




				REVISIONS	NUTH
designed _JML	<u>10/14/14</u>	DATE	BY	DESCRIPTION	ONWEALTH
drawn <u>JLH</u>	DATE <u>12/11/14</u>	03/09/15			
CHECKED <u>RES</u>	DATE <u>12/15/14</u> DATE				Lic. Nor 04010
APPROVED JML	01/14/15 DATE				ARCHITE
	DATE				*******

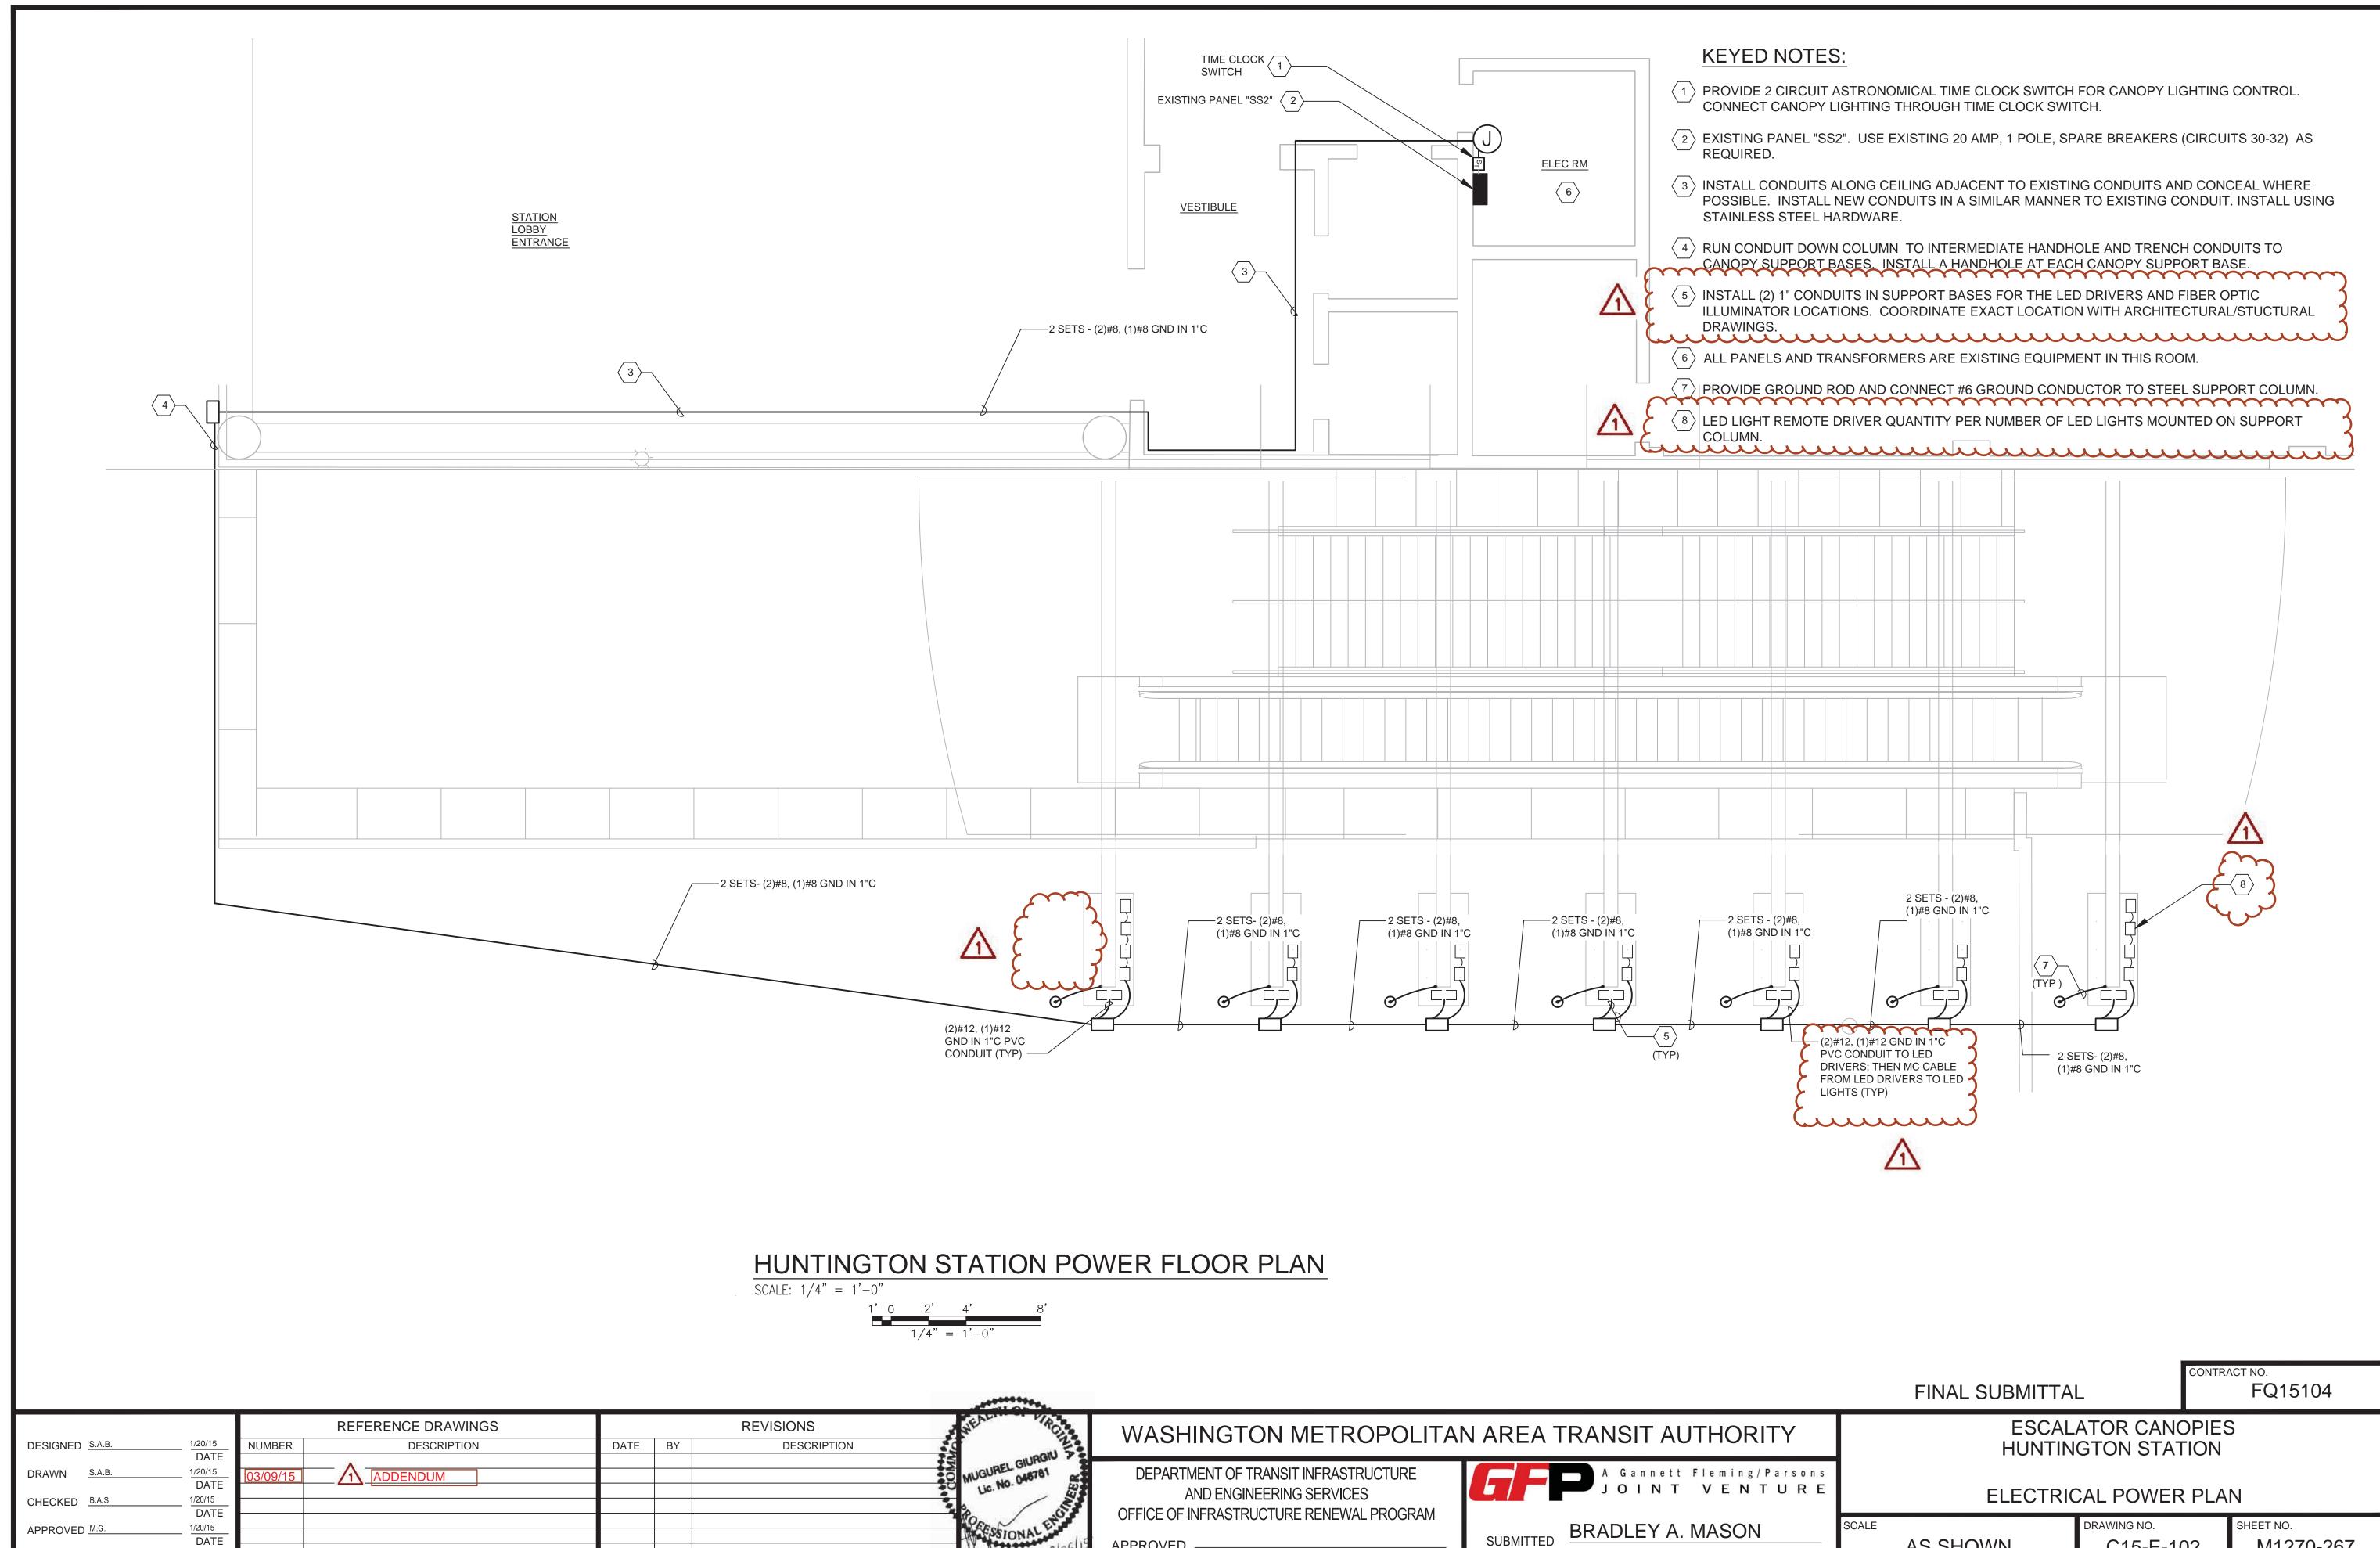



APPROVED PROJECT MANAGER

	FINAL SUBMITTA	_	FQ15104					
RITY	ESCALATOR CANOPIES HUNTINGTON STATION							
/Parsons TURE	ELECTRICAL POWER PLAN							
N	SCALE AS SHOWN	DRAWING NO. C15-E-102	SHEET NO. M1270-267					

	#	KEY	ED NOTES:			
	1.		LL BURIED CONDUIT MINIMUM OF 30" E	BFG .		
		INSTA EACH	LL HANDHOLD MINIMUM15" X 17" X 12" (COLUMN BASE FOR LED LIGHTING FIX ⁻ ITECTURAL/STRUCTURAL DRAWINGS F	CENTERED ON S TURES AND FIBE	R OPTIC	ILLUMINATOR. SE
	3.	COND	R TO STRUCTURAL DRAWINGS FOR EX UIT TO COLUMN BASE, TO LED REMOTI D FIXTURES.	ACT LOCATION (SS OPENING IN CO
	4.	PROVI	DE BEND RADIUS OF PVC CONDUIT AS	REQUIRED FOR	INSTALI	_ATION OF CONDU
	5.	PVC 1	CONDUIT TO FIBER OPTIC ILLUMINAT	ORS.		
_						
			\rightarrow			
						I II IK I T
						HUNT NO SCALE
	1/20/15		REFERENCE DRAWINGS			REVISIONS
DESIGNED <u>S.A.B.</u> DRAWN <u>S.A.B.</u>	DATE	NUMBER		DATE	BY	DESCRI
CHECKED <u>B.A.S.</u>	DATE =					
	1/20/15				<u> </u>	

DATE

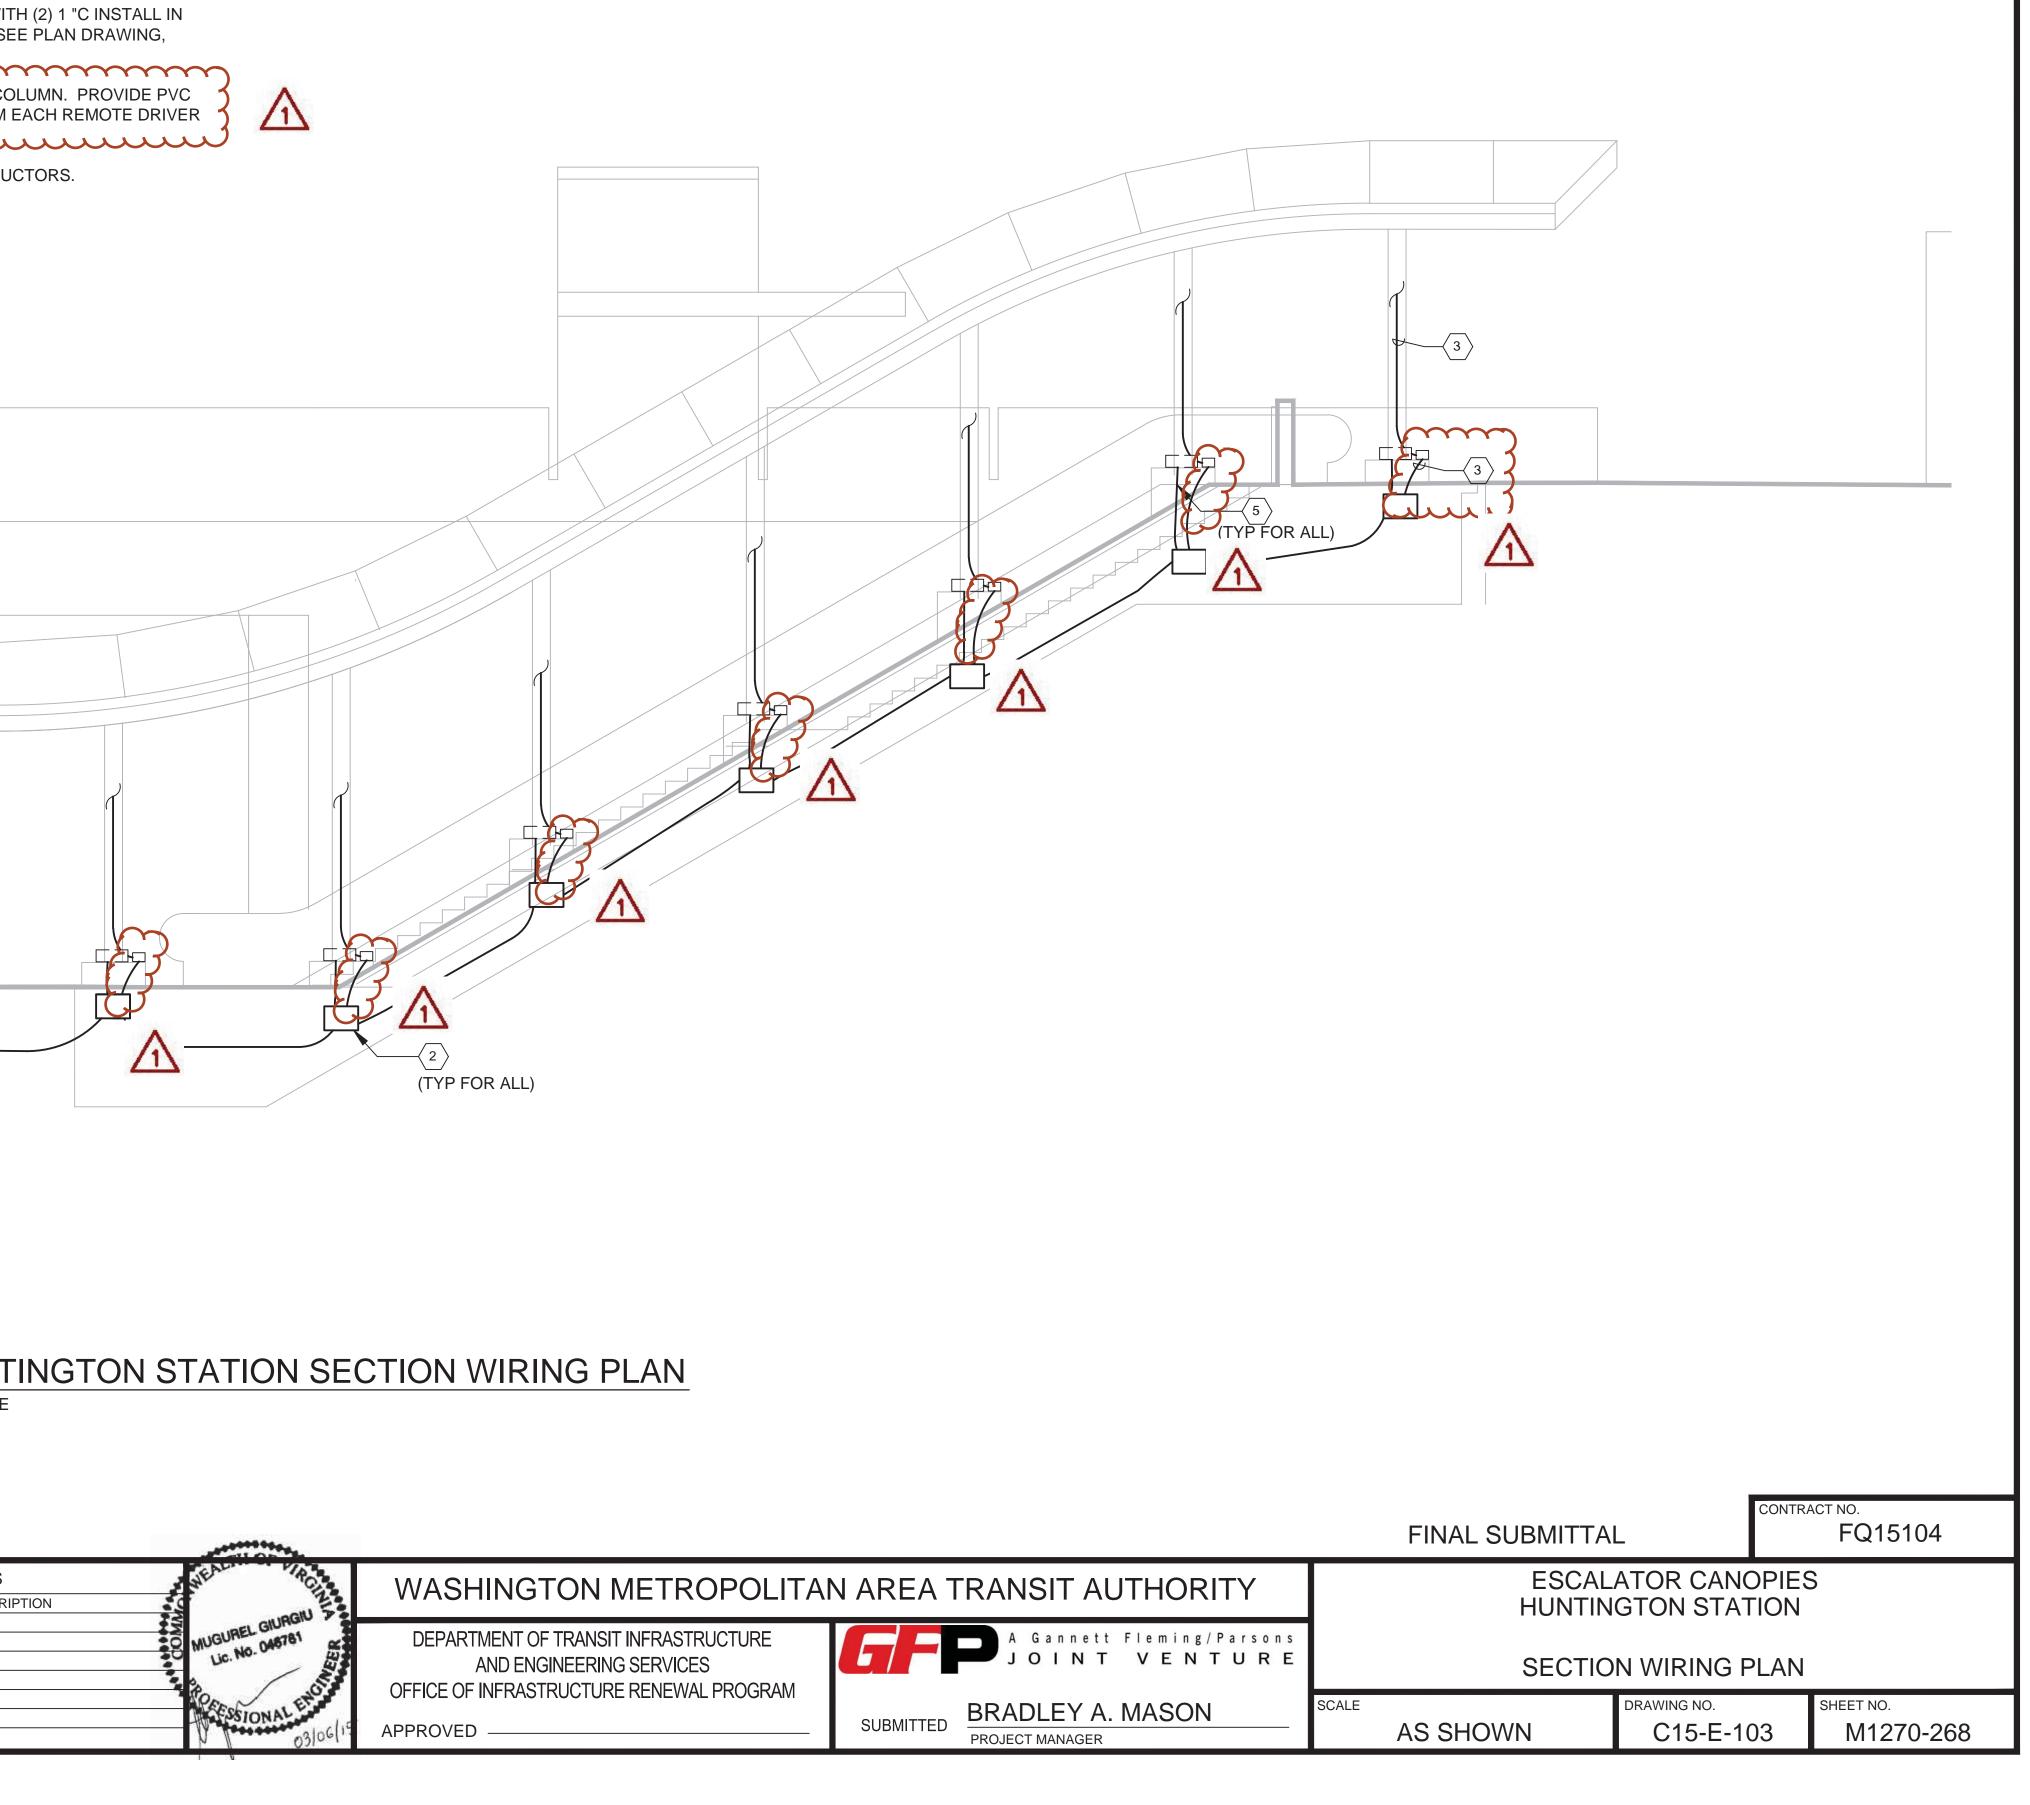

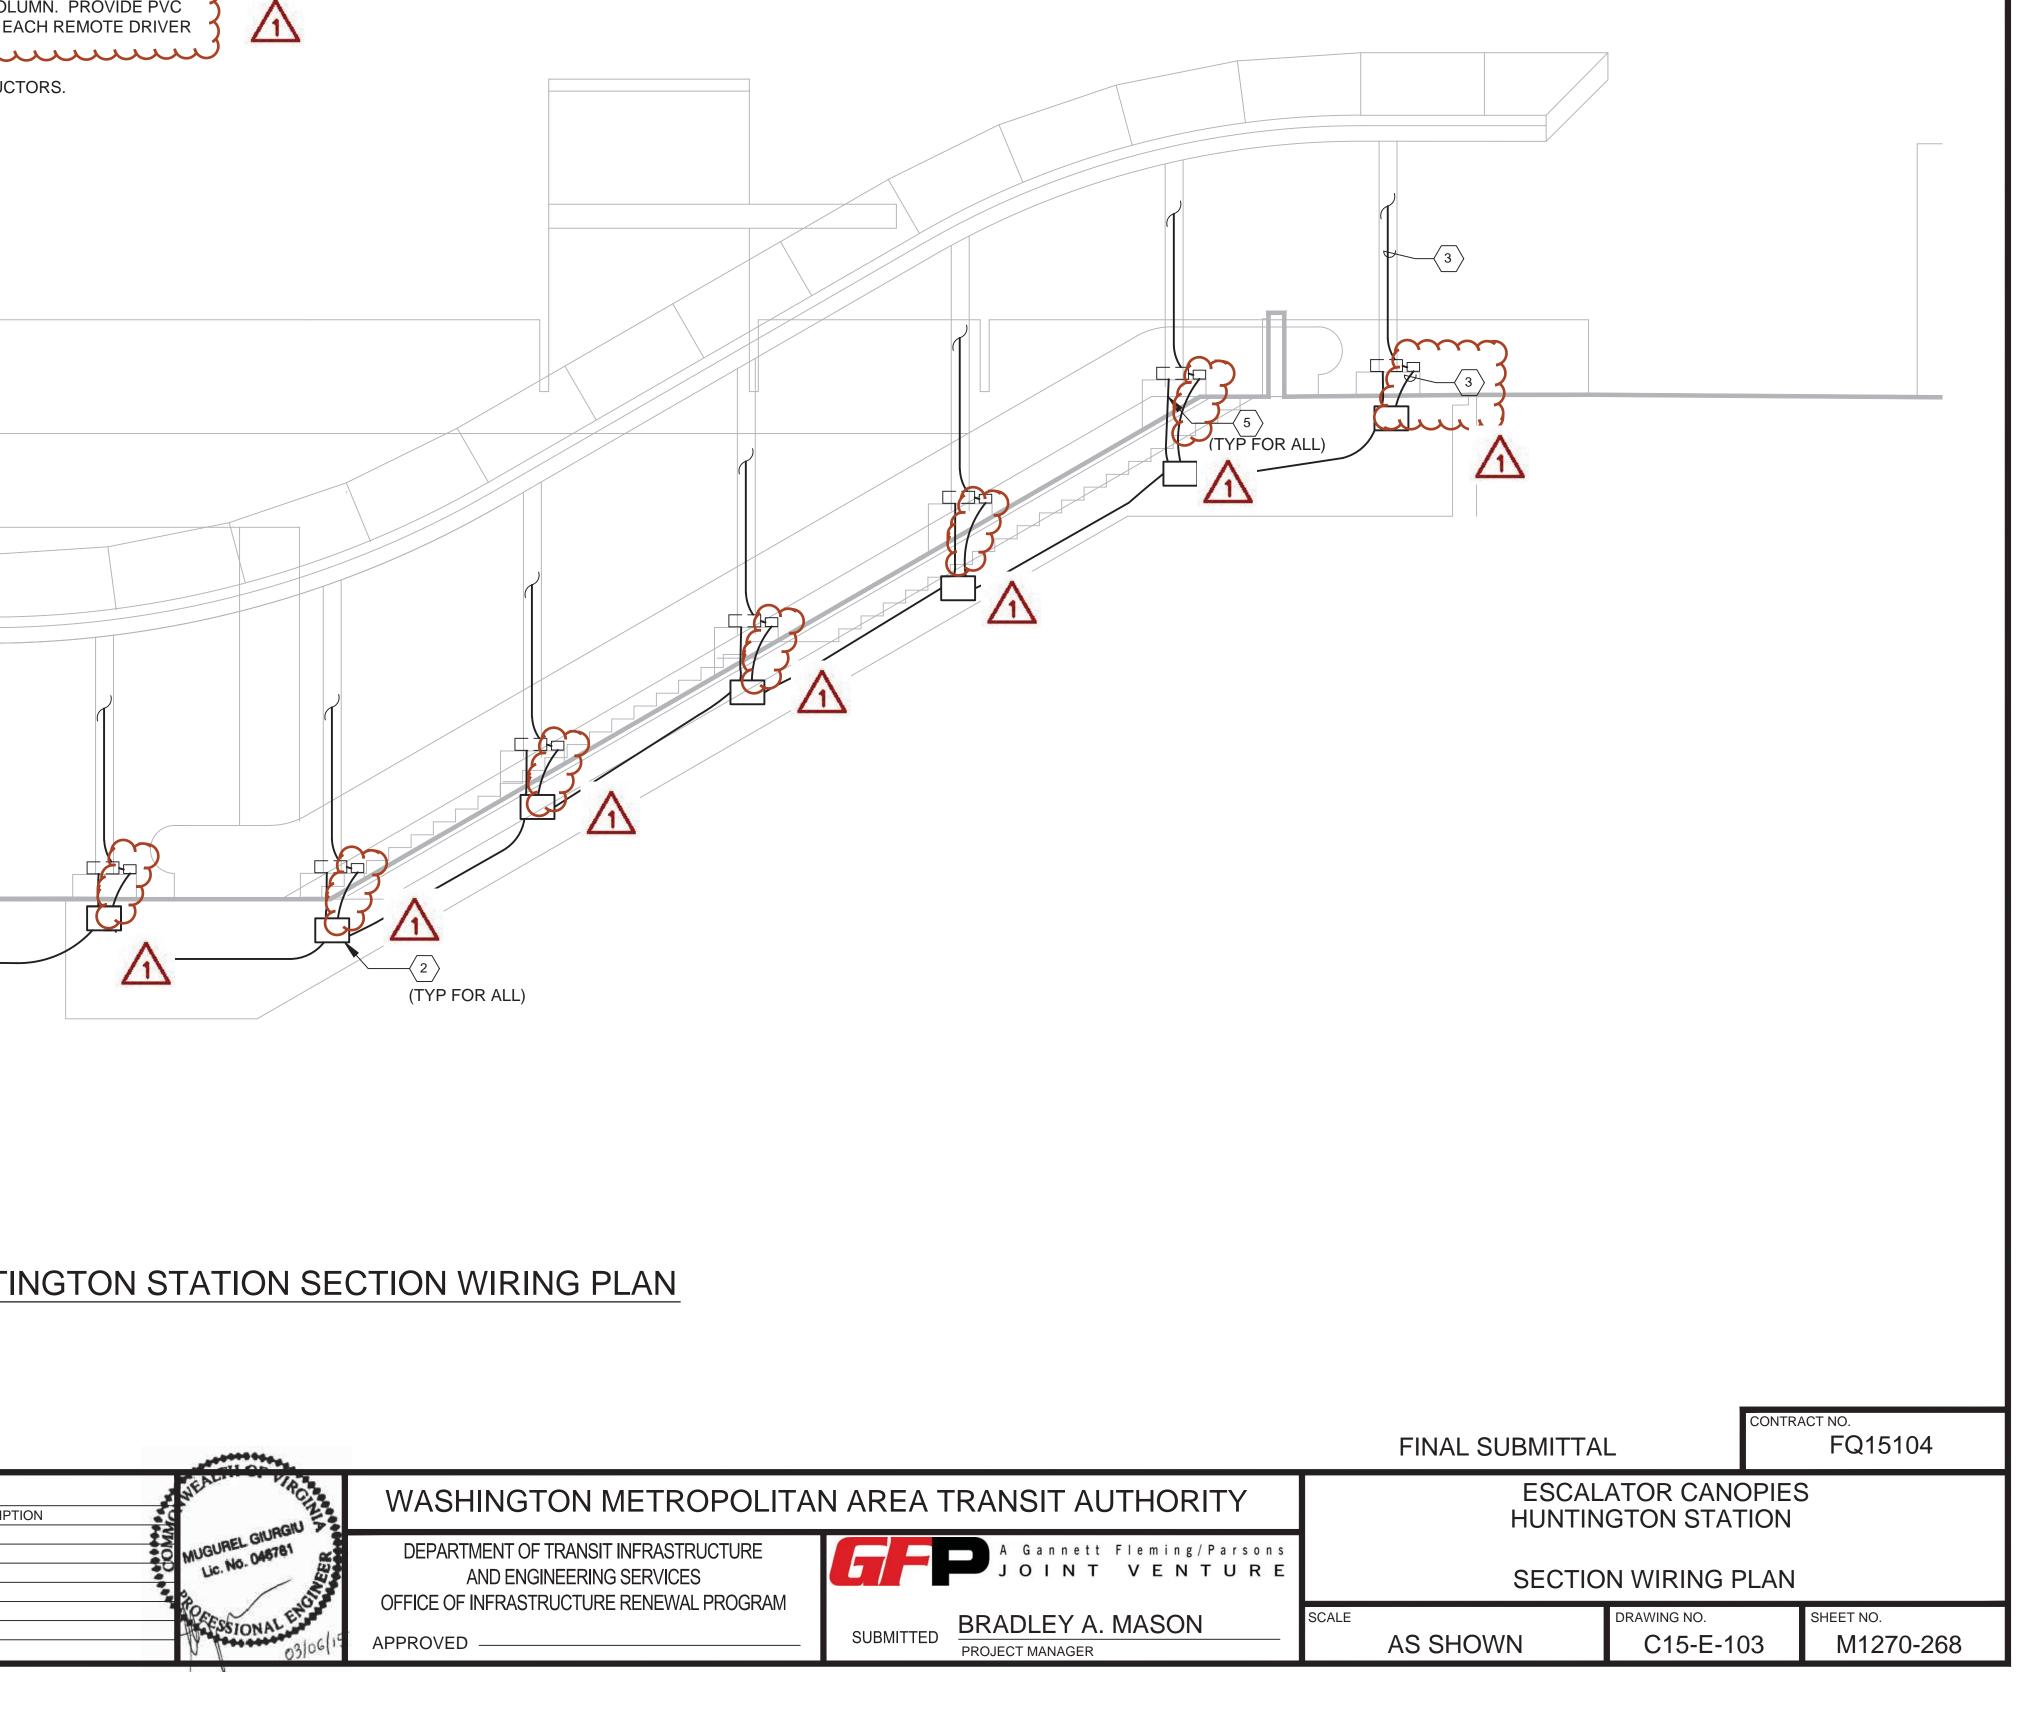


LIGHTING LEGEND TYPE L-1		/	\mathbf{i}		
LED DOW (REFER T TYPE L-2 FIBER OPTIC LIG (REFER TO SPE ILLUMINA FO-I FITT FIBER OF LED LIGH	(NLIGHT WITH REMOTE NON- TO SPEC 26 50 00) GHTING SYSTEM C 26 50 00)		FIXTURE. 2. INSTALL A 1 3. REFER TO S ROUTING A	DEVICE BOX 20VAC TO EA SHEET C15-E- ND LOCATION	AS DESCRIBED IN ACH FIBER OPTIC I 101 FOR MORE IN NS. RAL DRAWINGS FO
DESIGNED <u>S.A.B.</u>	1/20/15 NUMBER	EFERENCE DRAWINGS DESCRIPTION	DA	TE BY	HUNT SCALE: 1/4 REVISIONS DESCRI
DRAWN <u>S.A.B.</u> CHECKED <u>B.A.S.</u> APPROVED <u>M.G.</u>	DATE <u>1/20/15</u> DATE <u>1/20/15</u> DATE <u>1/20/15</u> DATE <u>1/20/15</u> DATE	ADDENDUM			


I SPEC 26 05 33.23 SHALL BE USED AT EACH LED LIGHT


ILLUMINATOR AT EACH COLUMN.

IFORMATION ON THE CONDUIT AND CONDUCTOR

OR MORE INFORMATION.

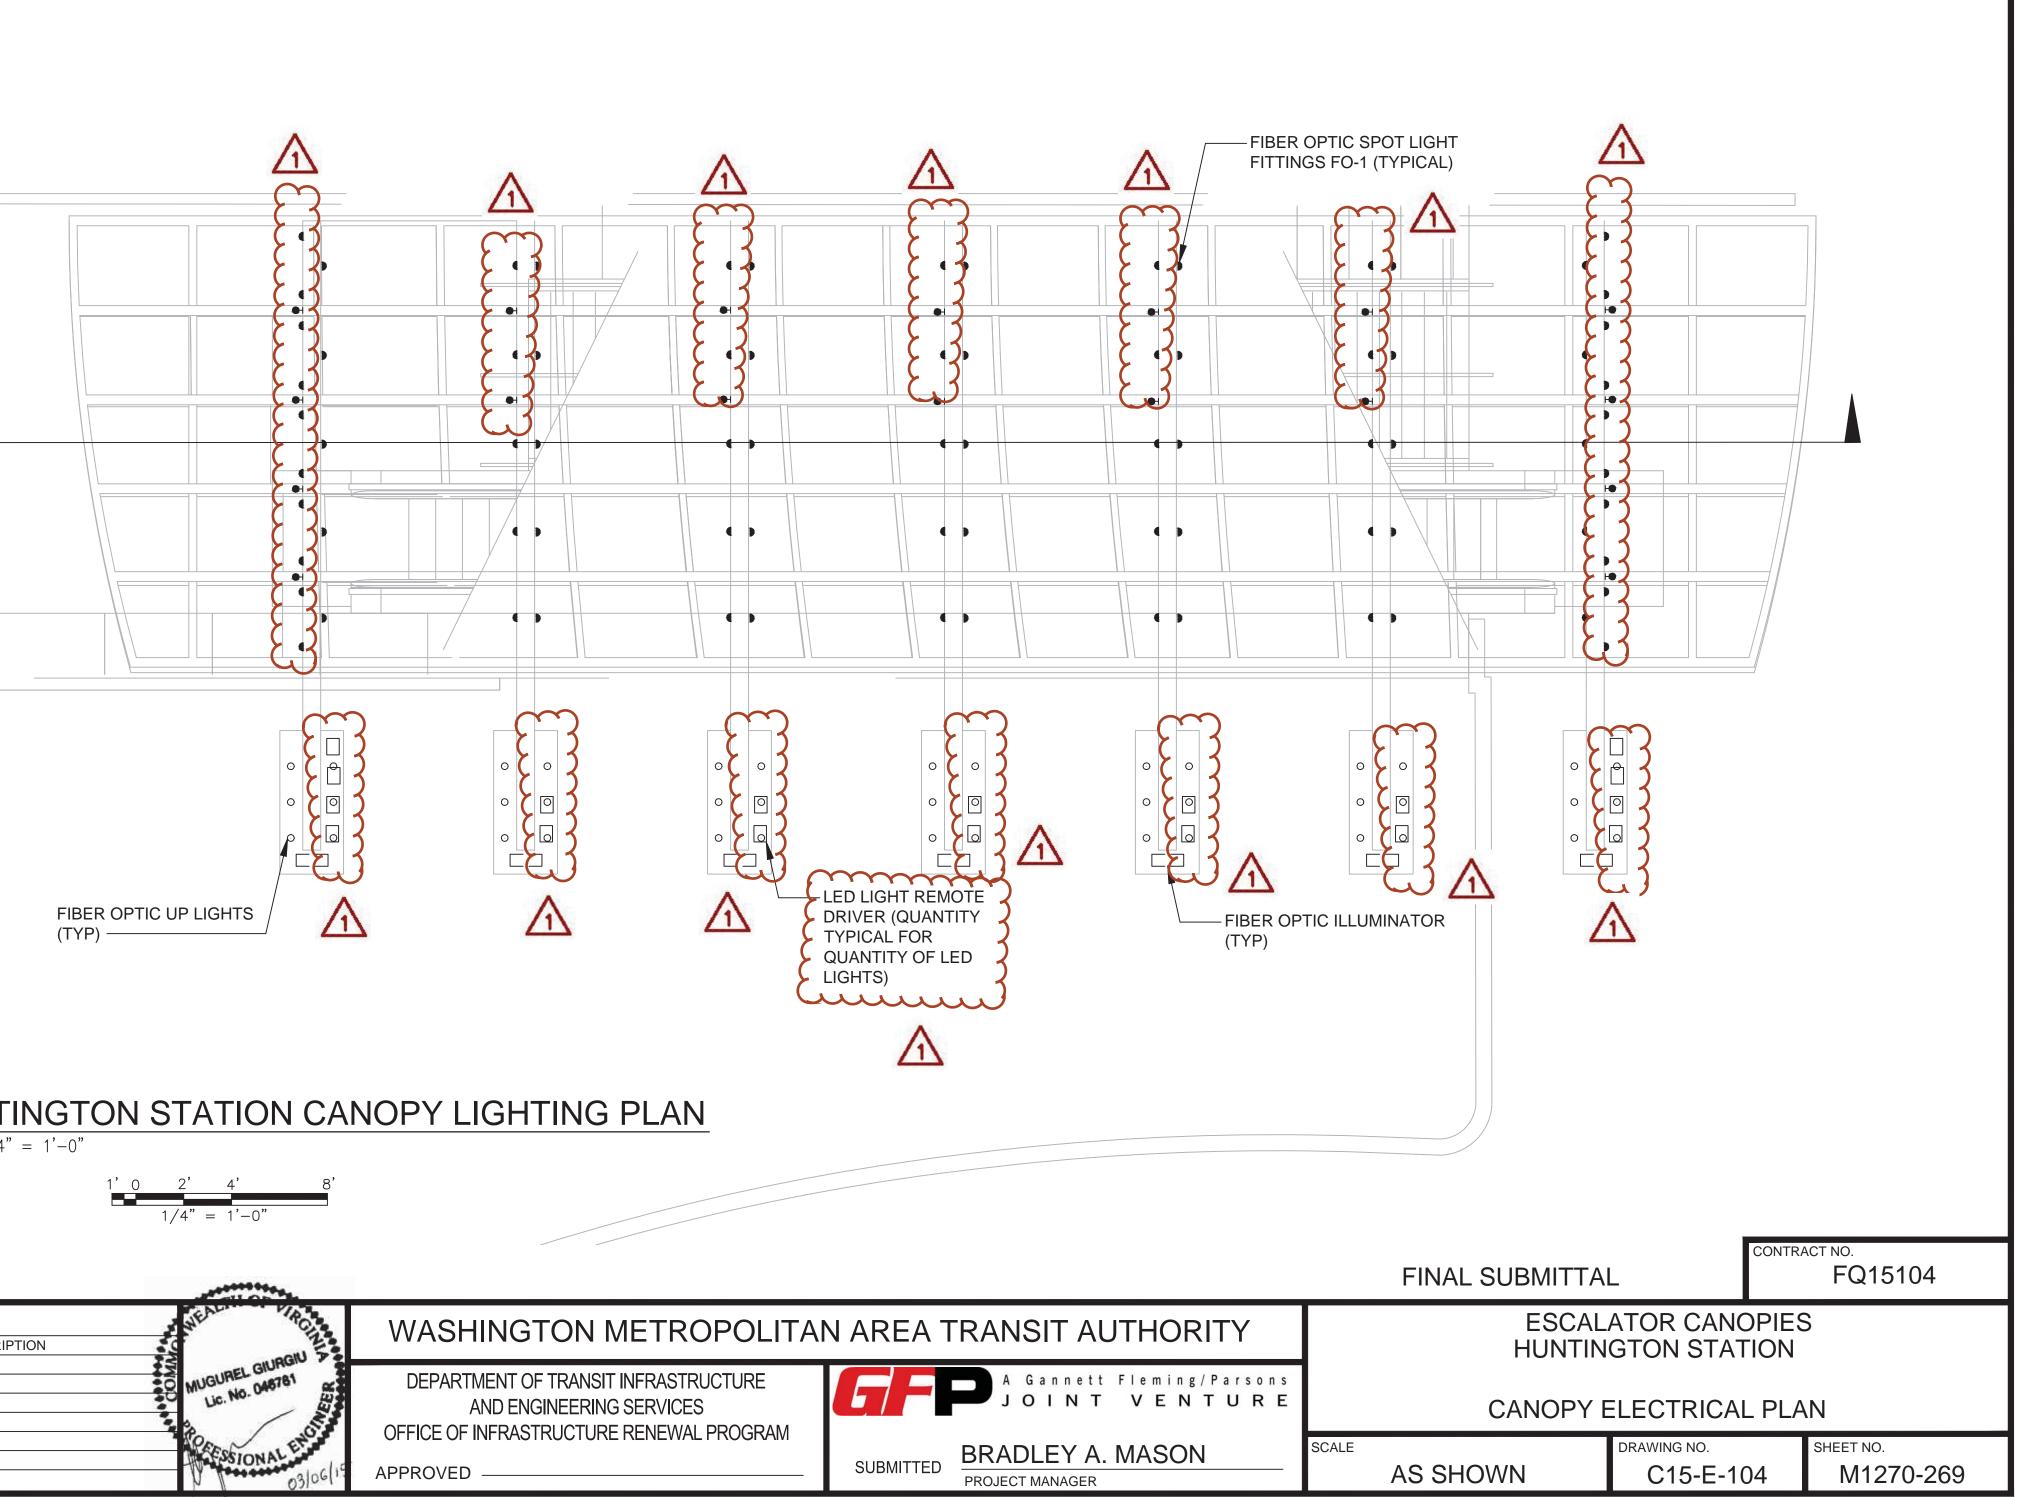

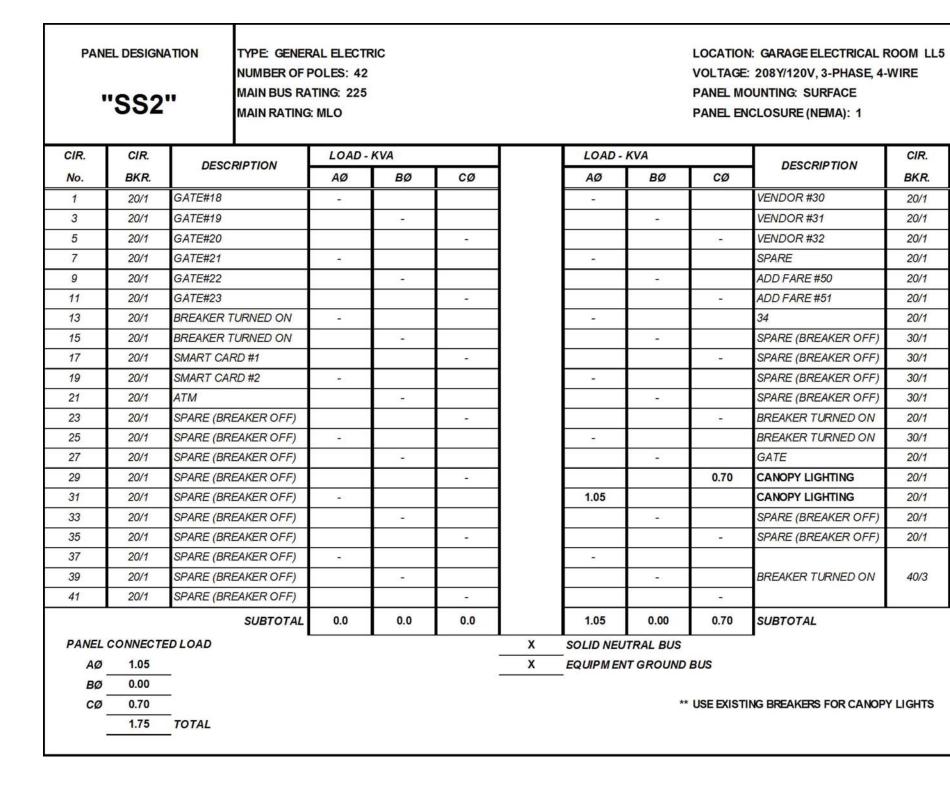

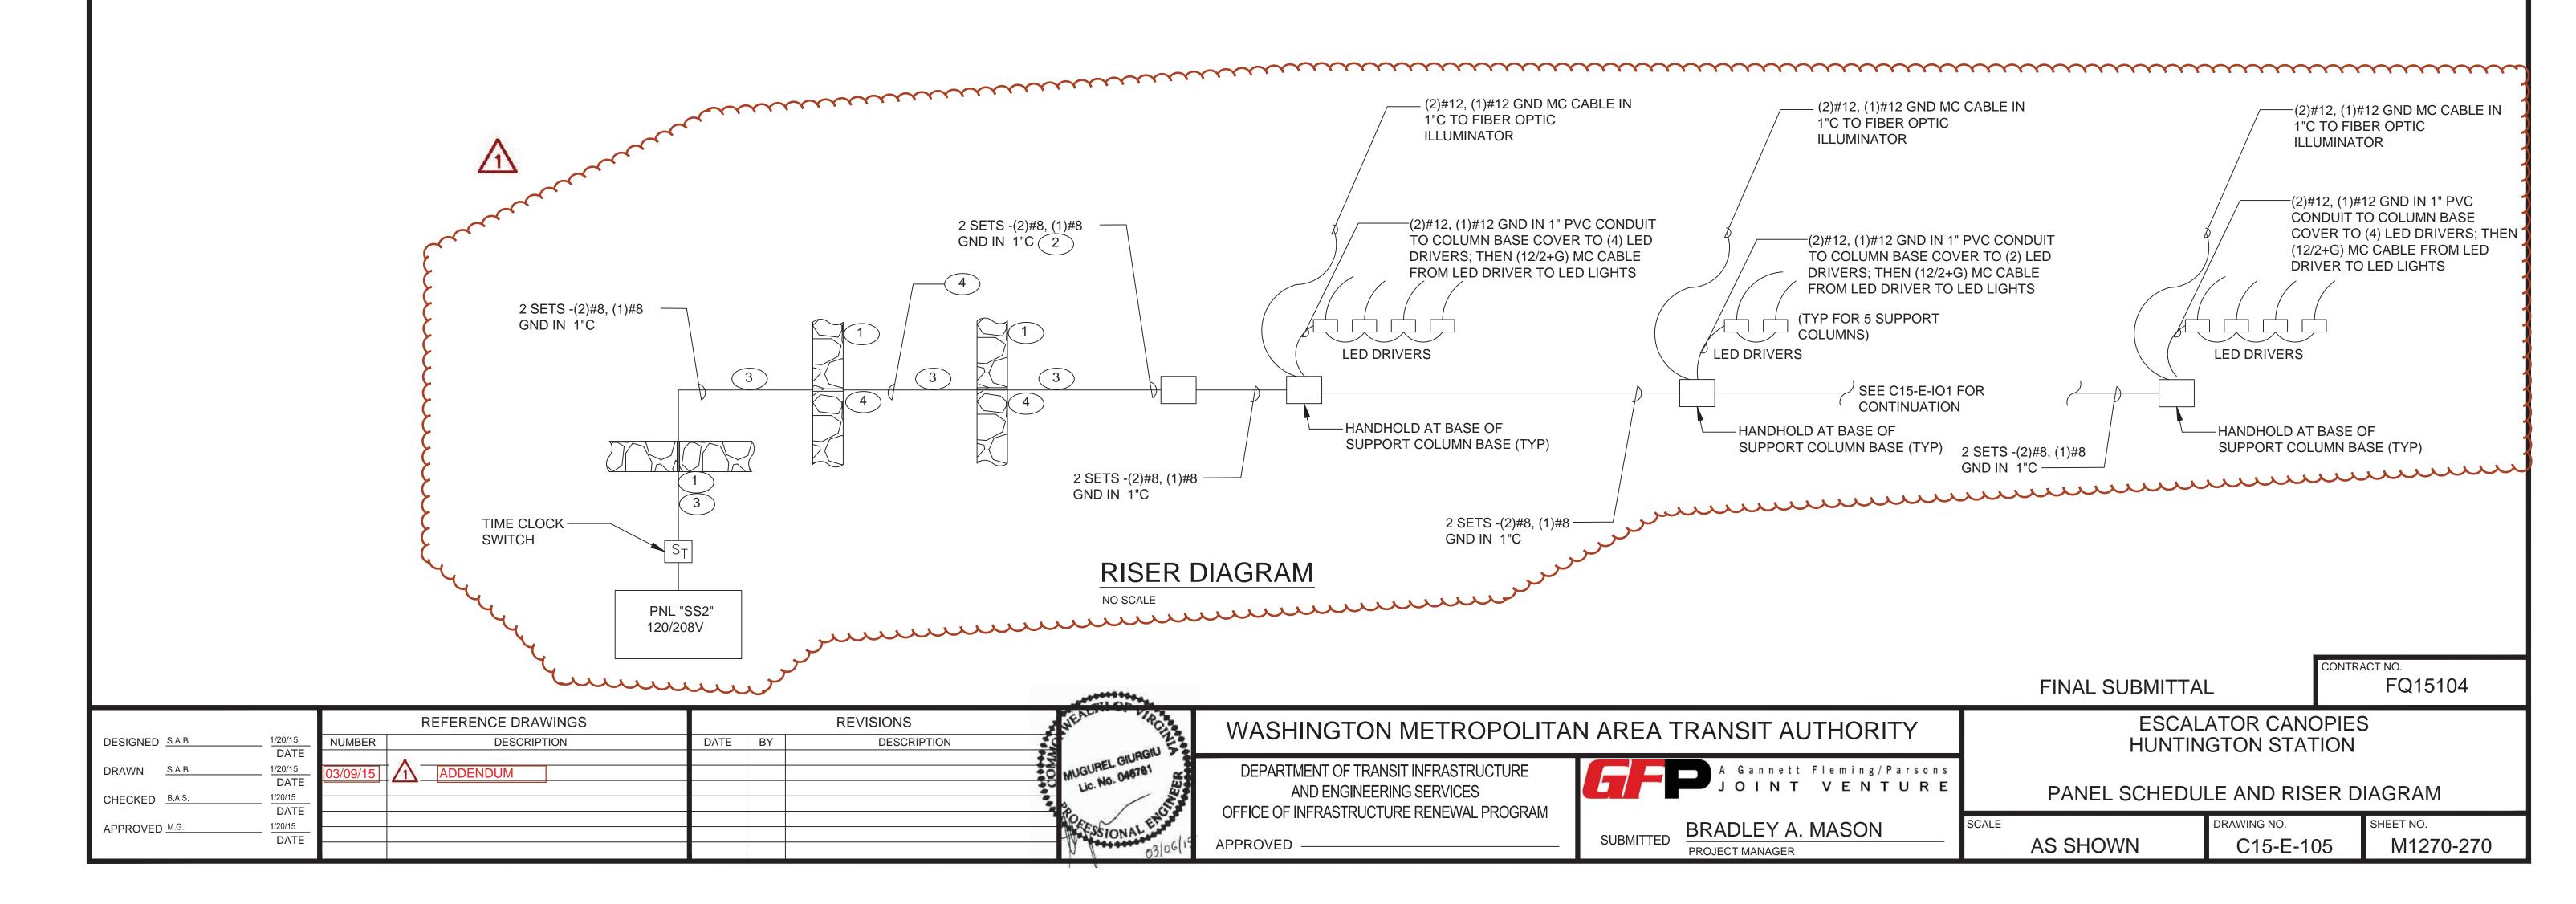

NOTES:

	CIR.	
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) CONCRETE/GRANITE WALL PENETRATION REQUIRED, SLEEVE AND SEAL AT (1)OPENINGS.

(2) ROUTE CONDUIT AND CONDUCTORS EXPOSED DOWN COLUMN TO NEW HANDHOLD.



(3) ROUTE CONDUIT WITH CONDUCTORS PARALLEL TO EXISTING CONDUITS. CONCEAL WHERE POSSIBLE. INSTALL IN A SIMILAR MANNER TO EXISTING. MOUNTING HARDWARE SHALL BE STAINLESS STEEL.

4 WHERE PRACTICAL AND ALLOWED. INSTALLATION OF A CONDULET PREFERRED OVER JUNCTION BOX IN LOCATIONS VISIBLE TO PUBLIC. REFER TO OTHER DRAWINGS FOR INDICATED LOCATIONS.