




				REVISIONS	NUTH
designed _JML	<u>10/14/14</u>	DATE	BY	DESCRIPTION	ONWEALTH
drawn <u>JLH</u>	DATE <u>12/11/14</u>	03/09/15			
CHECKED <u>RES</u>	DATE <u>12/15/14</u> DATE				Lic. Nor 04010
APPROVED JML	01/14/15 DATE				ARCHITE
	DATE				*******

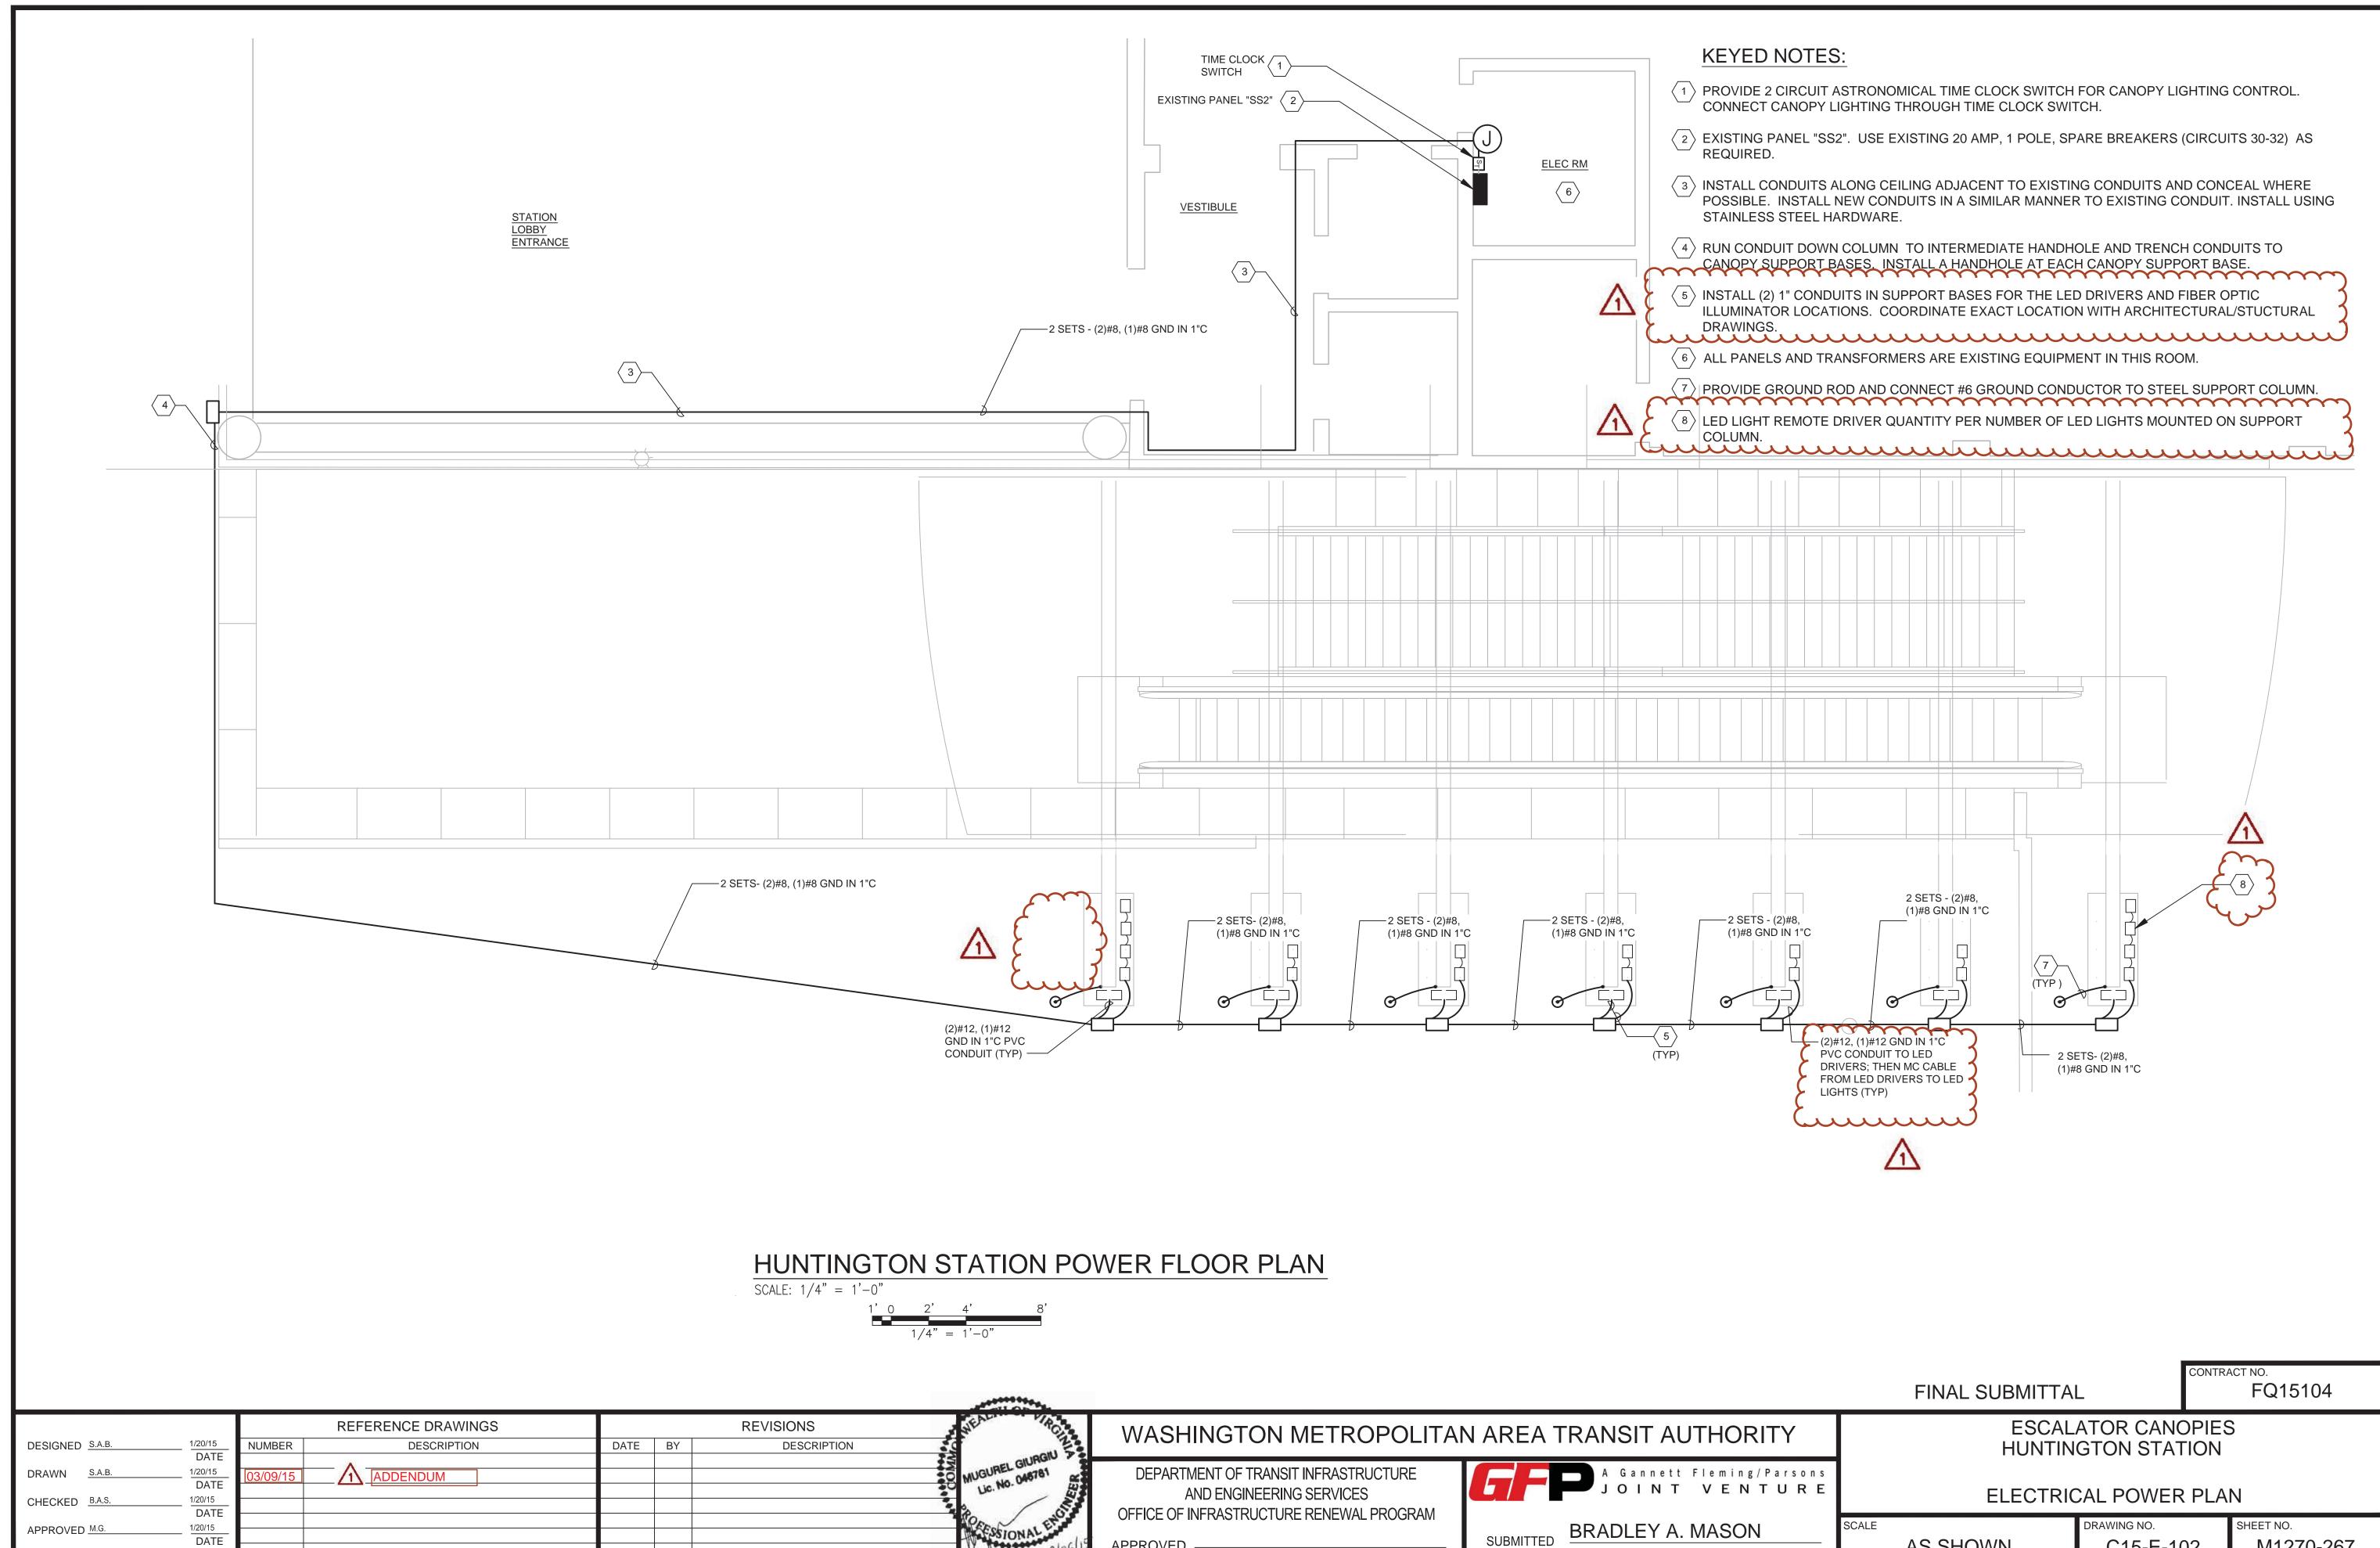



# APPROVED PROJECT MANAGER

	FINAL SUBMITTA	_	FQ15104					
RITY	ESCALATOR CANOPIES HUNTINGTON STATION							
/Parsons TURE	ELECTRICAL POWER PLAN							
N	SCALE AS SHOWN	DRAWING NO. C15-E-102	SHEET NO. M1270-267					

	#	KEY	ED NOTES:			
	1.		LL BURIED CONDUIT MINIMUM OF 30" E	BFG .		
		INSTA EACH	LL HANDHOLD MINIMUM15" X 17" X 12" ( COLUMN BASE FOR LED LIGHTING FIX <sup>-</sup> ITECTURAL/STRUCTURAL DRAWINGS F	CENTERED ON S TURES AND FIBE	R OPTIC	ILLUMINATOR. SE
	3.	COND	R TO STRUCTURAL DRAWINGS FOR EX UIT TO COLUMN BASE, TO LED REMOTI D FIXTURES.	ACT LOCATION (		SS OPENING IN CO
	4.	PROVI	DE BEND RADIUS OF PVC CONDUIT AS	REQUIRED FOR	INSTALI	_ATION OF CONDU
	5.	PVC 1	CONDUIT TO FIBER OPTIC ILLUMINAT	ORS.		
_						
			$\rightarrow$			
						I II IK I <del>T</del>
						HUNT NO SCALE
	1/20/15		REFERENCE DRAWINGS			REVISIONS
DESIGNED <u>S.A.B.</u> DRAWN <u>S.A.B.</u>	DATE	NUMBER		DATE	BY	DESCRI
CHECKED <u>B.A.S.</u>	DATE =					
	1/20/15				<u>                                     </u>	

DATE

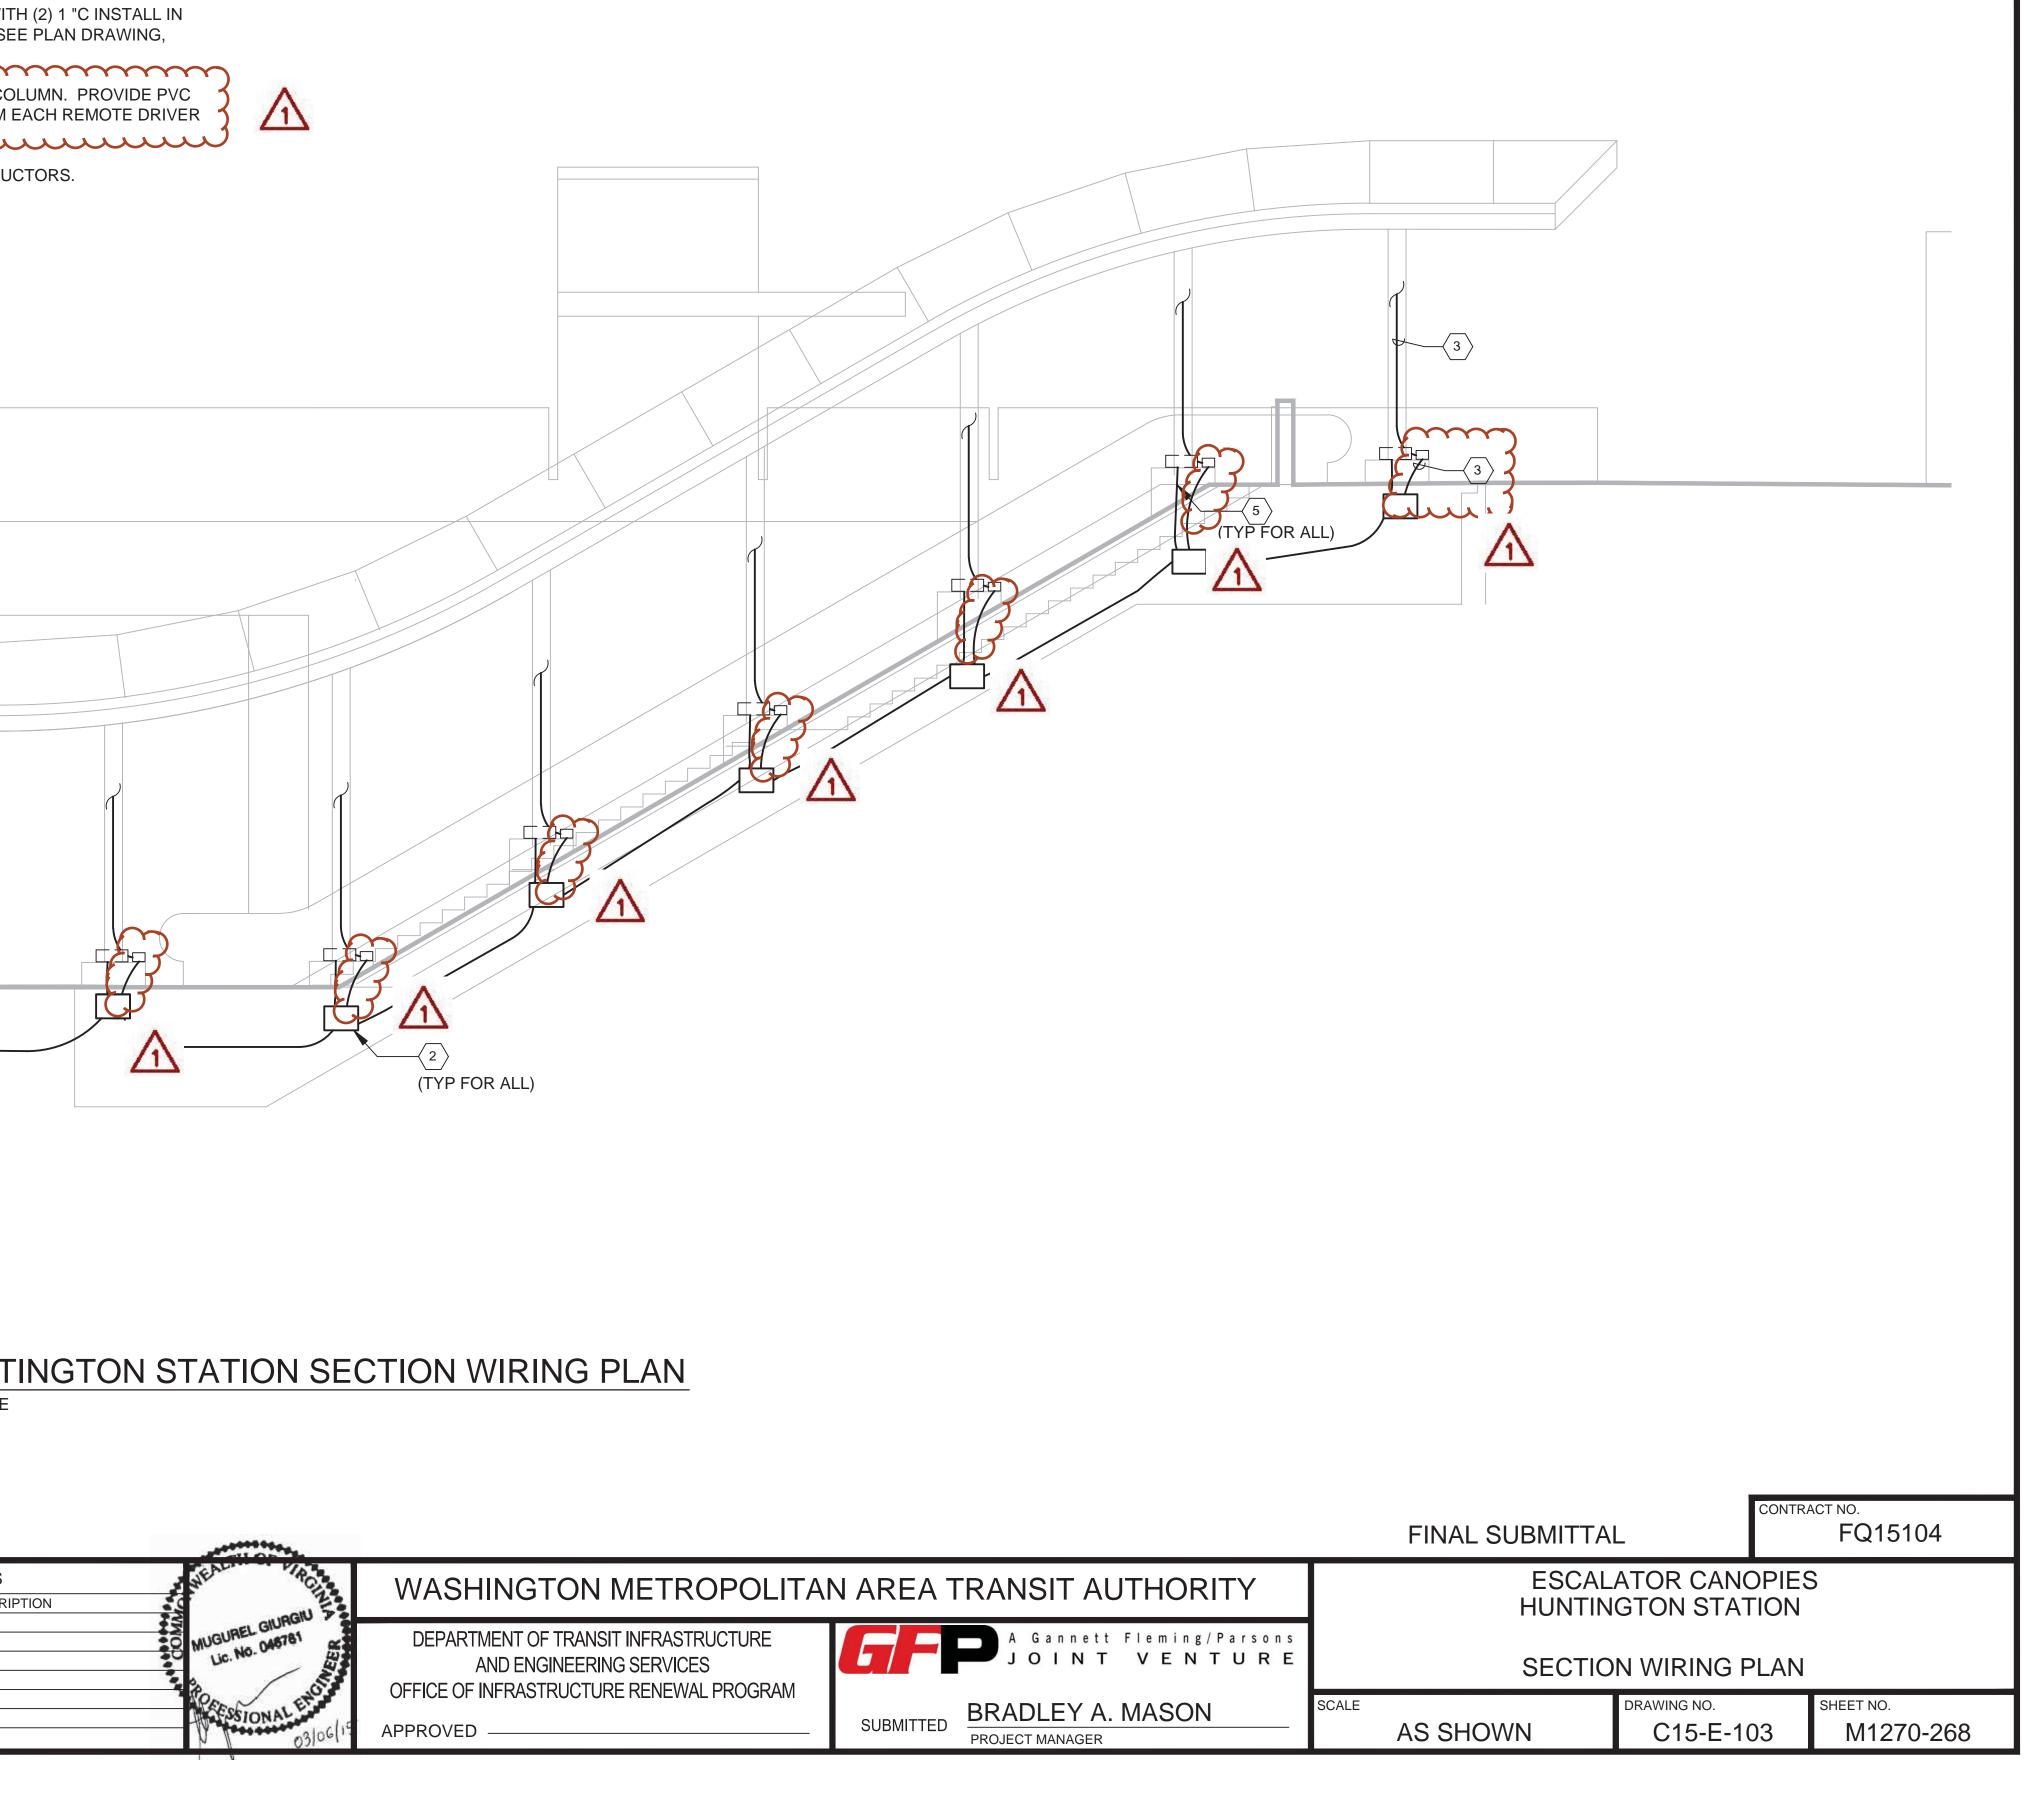

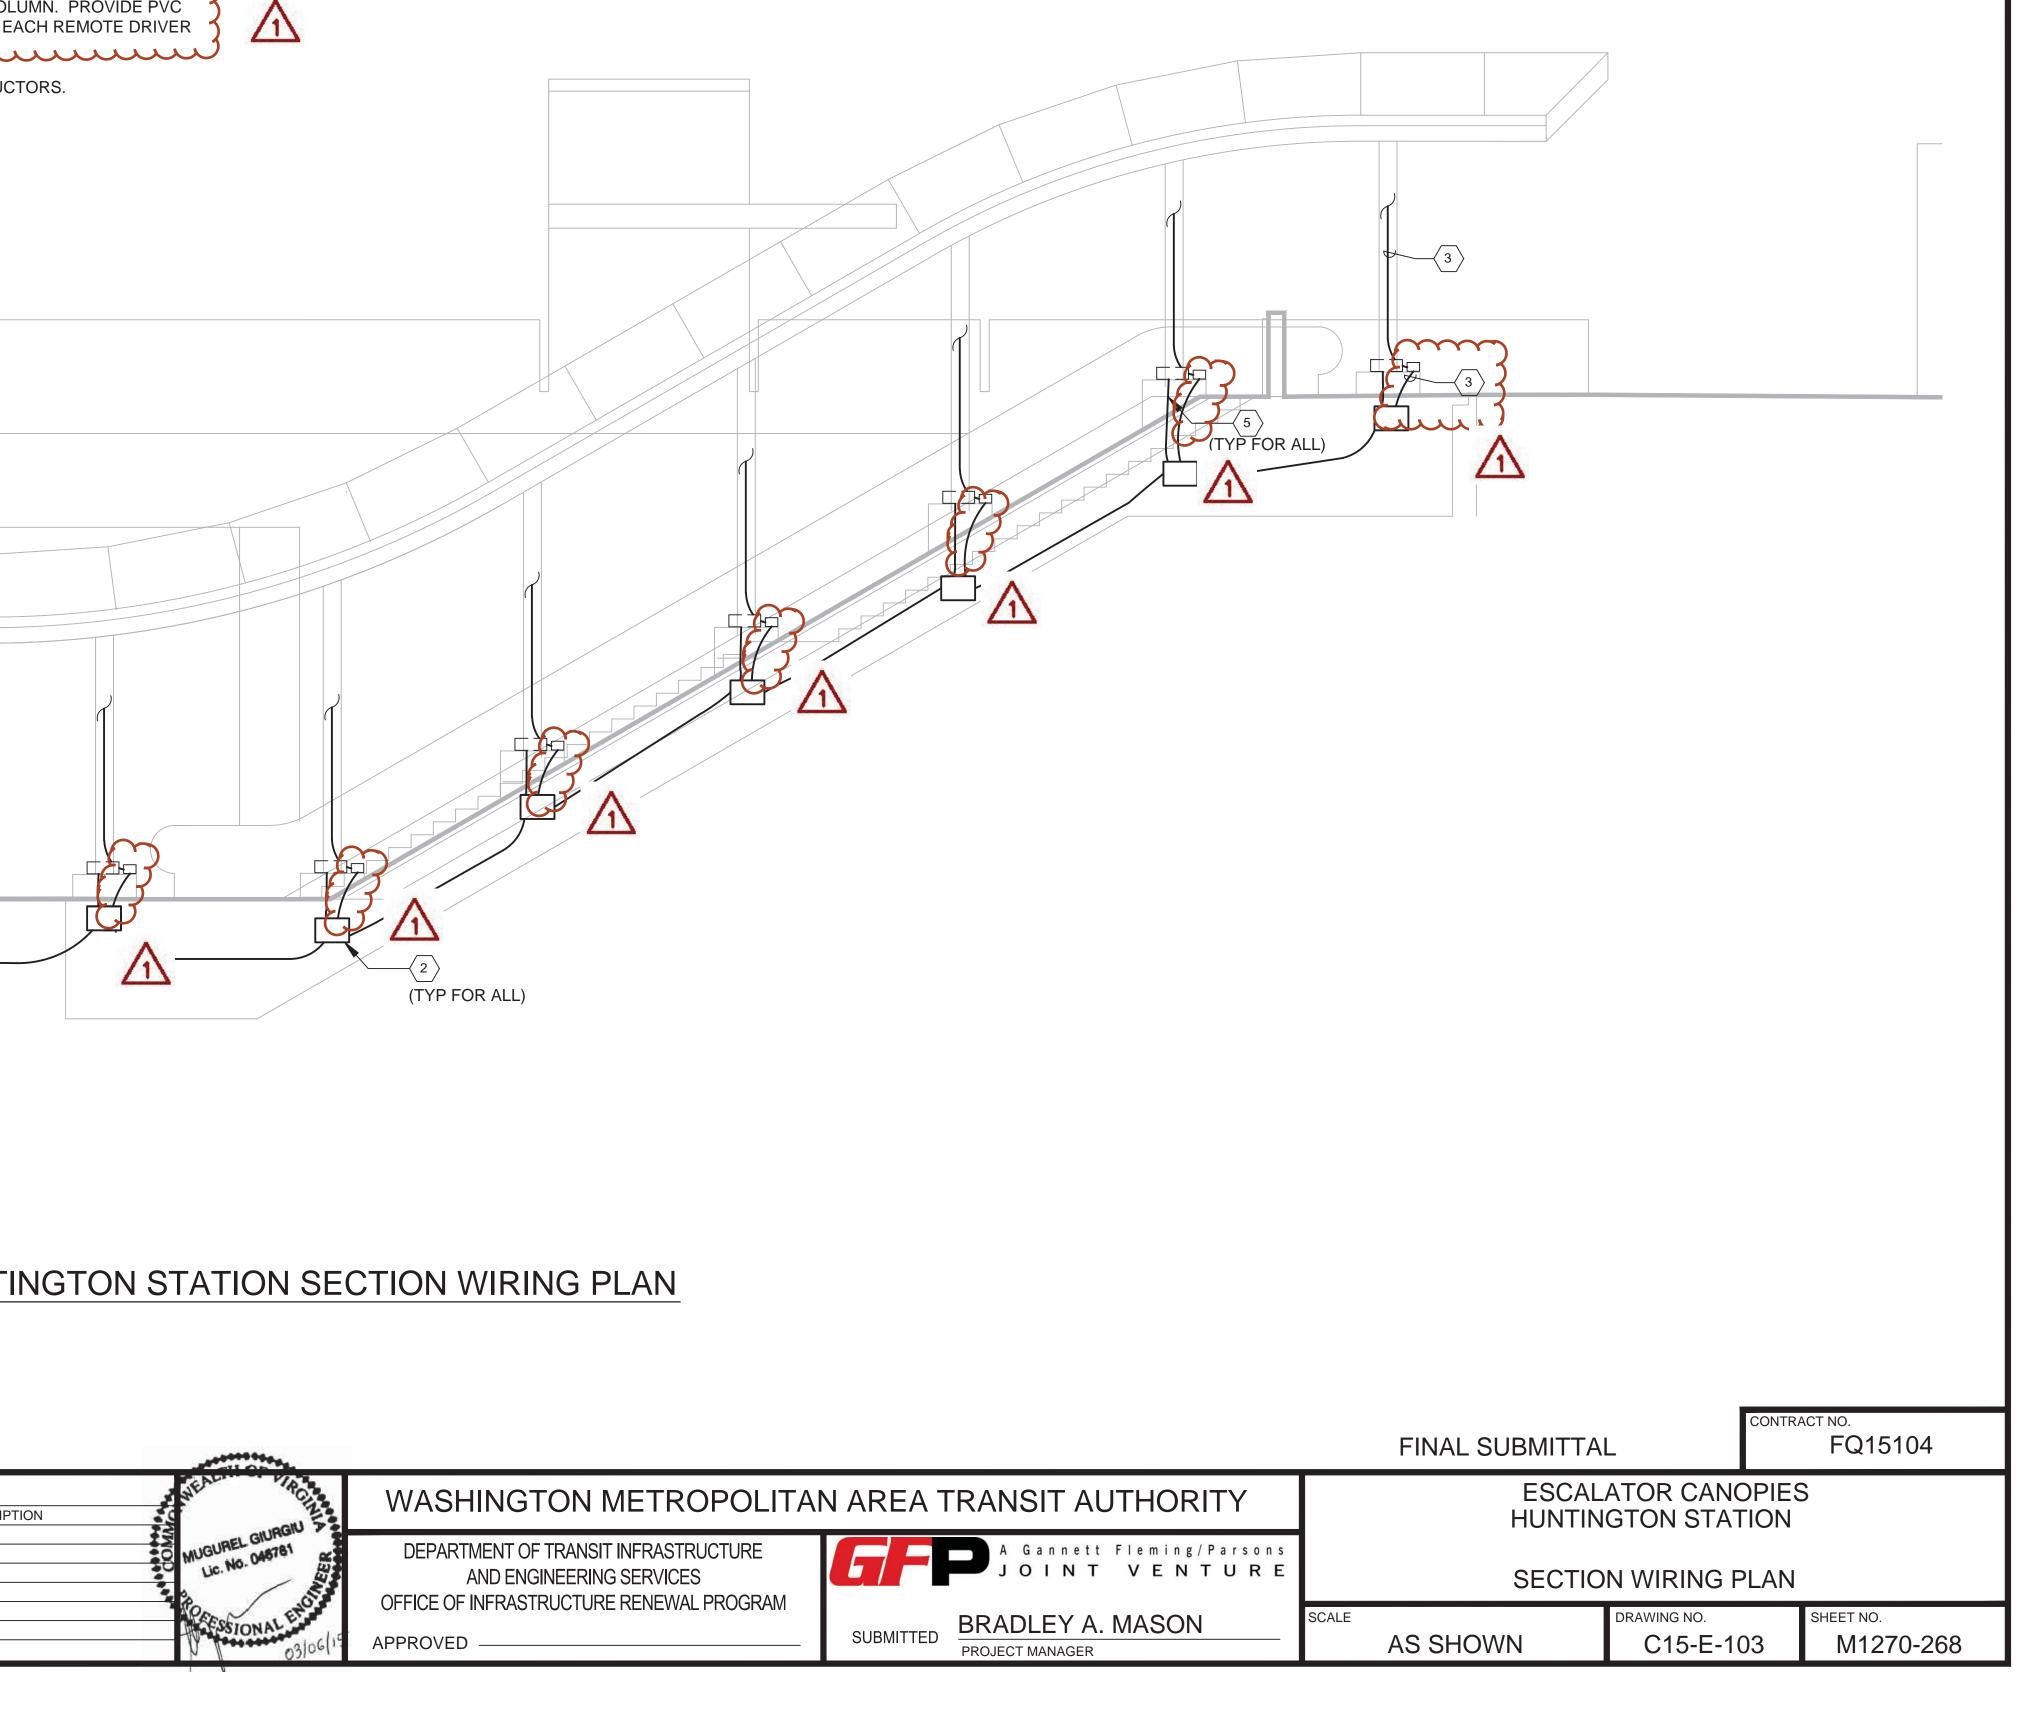


LIGHTING LEGEND TYPE L-1		/	$\mathbf{i}$		
LED DOW (REFER T TYPE L-2 FIBER OPTIC LIG (REFER TO SPE ILLUMINA FO-I FITT FIBER OF LED LIGH	(NLIGHT WITH REMOTE NON- TO SPEC 26 50 00) GHTING SYSTEM C 26 50 00)		FIXTURE. 2. INSTALL A 1 3. REFER TO S ROUTING A	DEVICE BOX 20VAC TO EA SHEET C15-E- ND LOCATION	AS DESCRIBED IN ACH FIBER OPTIC I 101 FOR MORE IN NS. RAL DRAWINGS FO
DESIGNED <u>S.A.B.</u>	1/20/15 NUMBER	EFERENCE DRAWINGS DESCRIPTION	DA	TE BY	HUNT SCALE: 1/4 REVISIONS DESCRI
DRAWN <u>S.A.B.</u> CHECKED <u>B.A.S.</u> APPROVED <u>M.G.</u>	DATE <u>1/20/15</u> DATE <u>1/20/15</u> DATE <u>1/20/15</u> DATE <u>1/20/15</u> DATE	ADDENDUM			


I SPEC 26 05 33.23 SHALL BE USED AT EACH LED LIGHT


ILLUMINATOR AT EACH COLUMN.

IFORMATION ON THE CONDUIT AND CONDUCTOR

OR MORE INFORMATION.

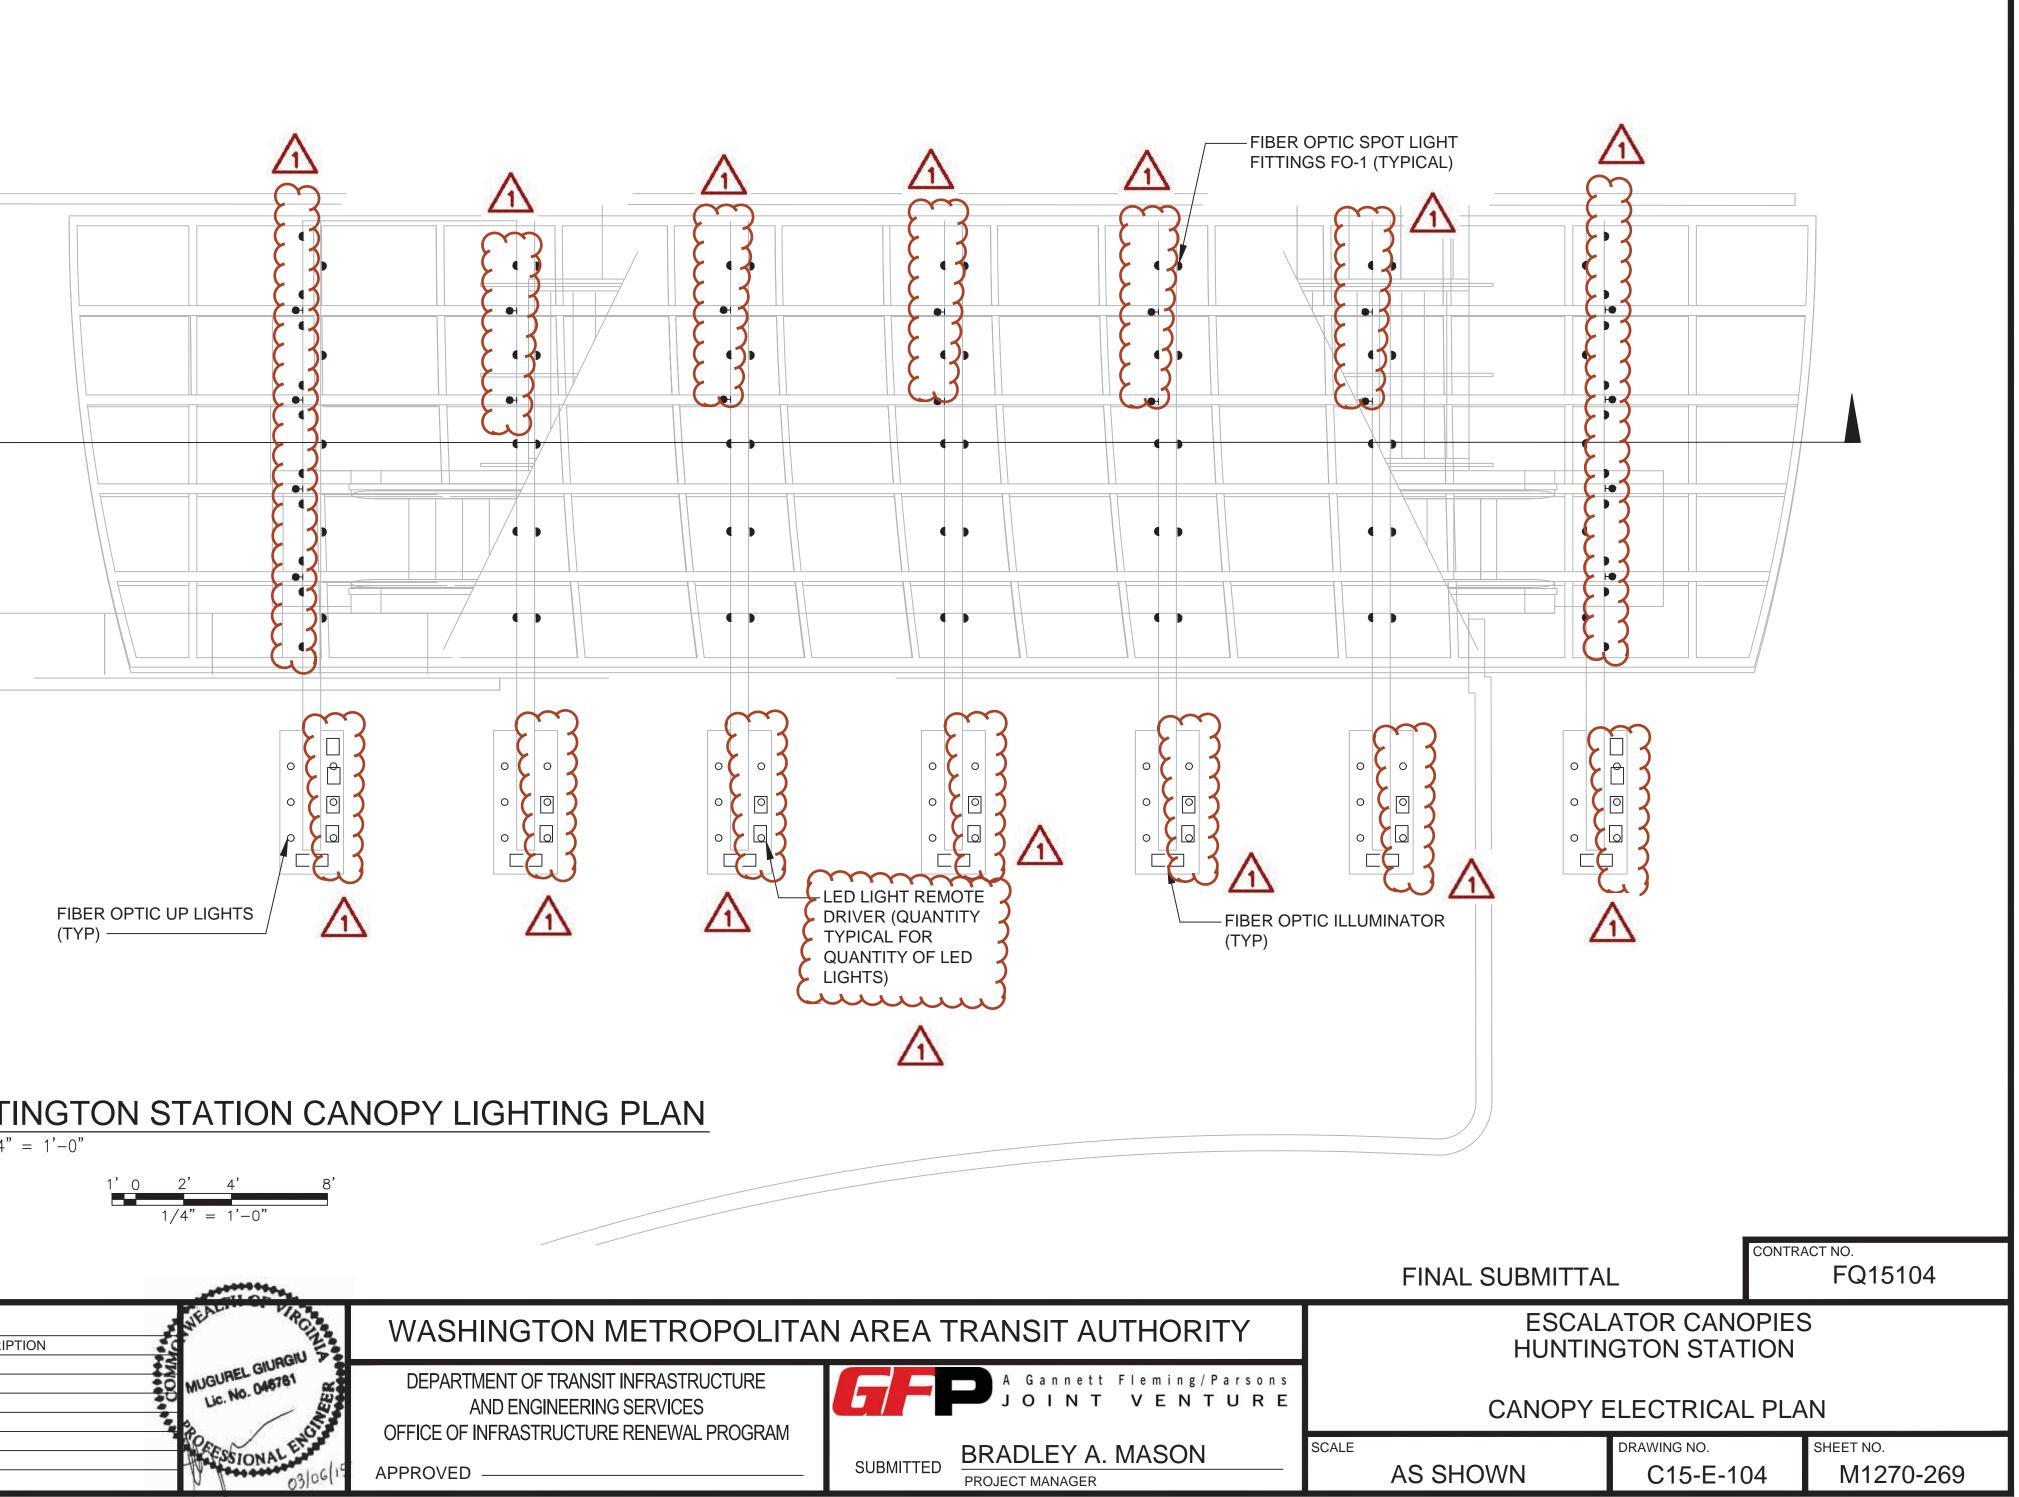

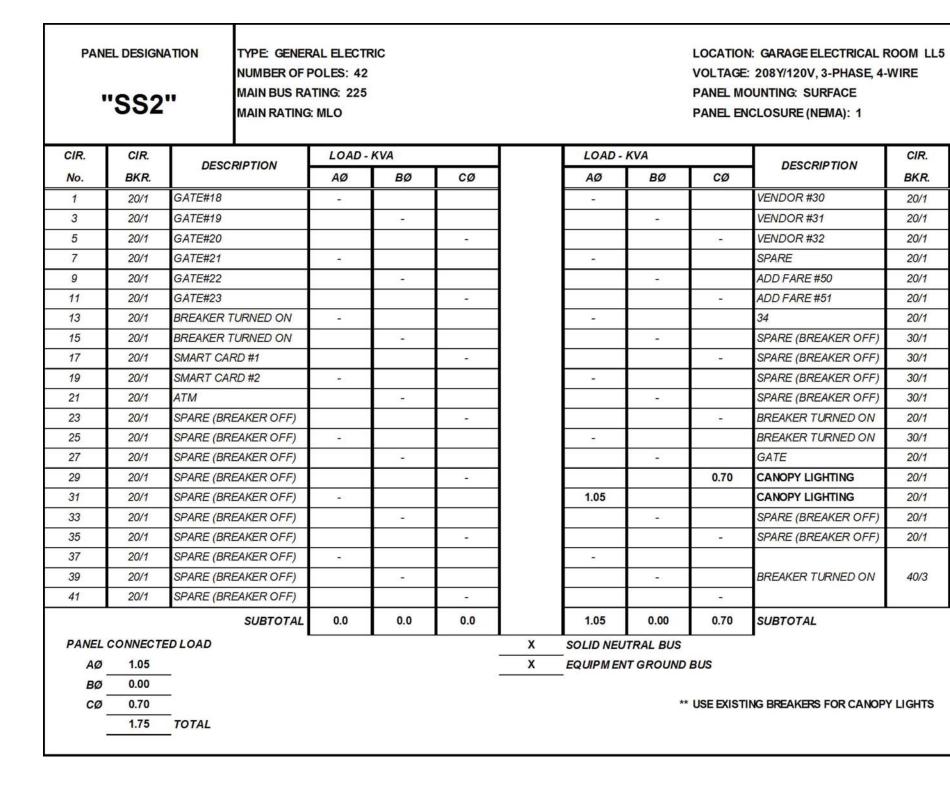

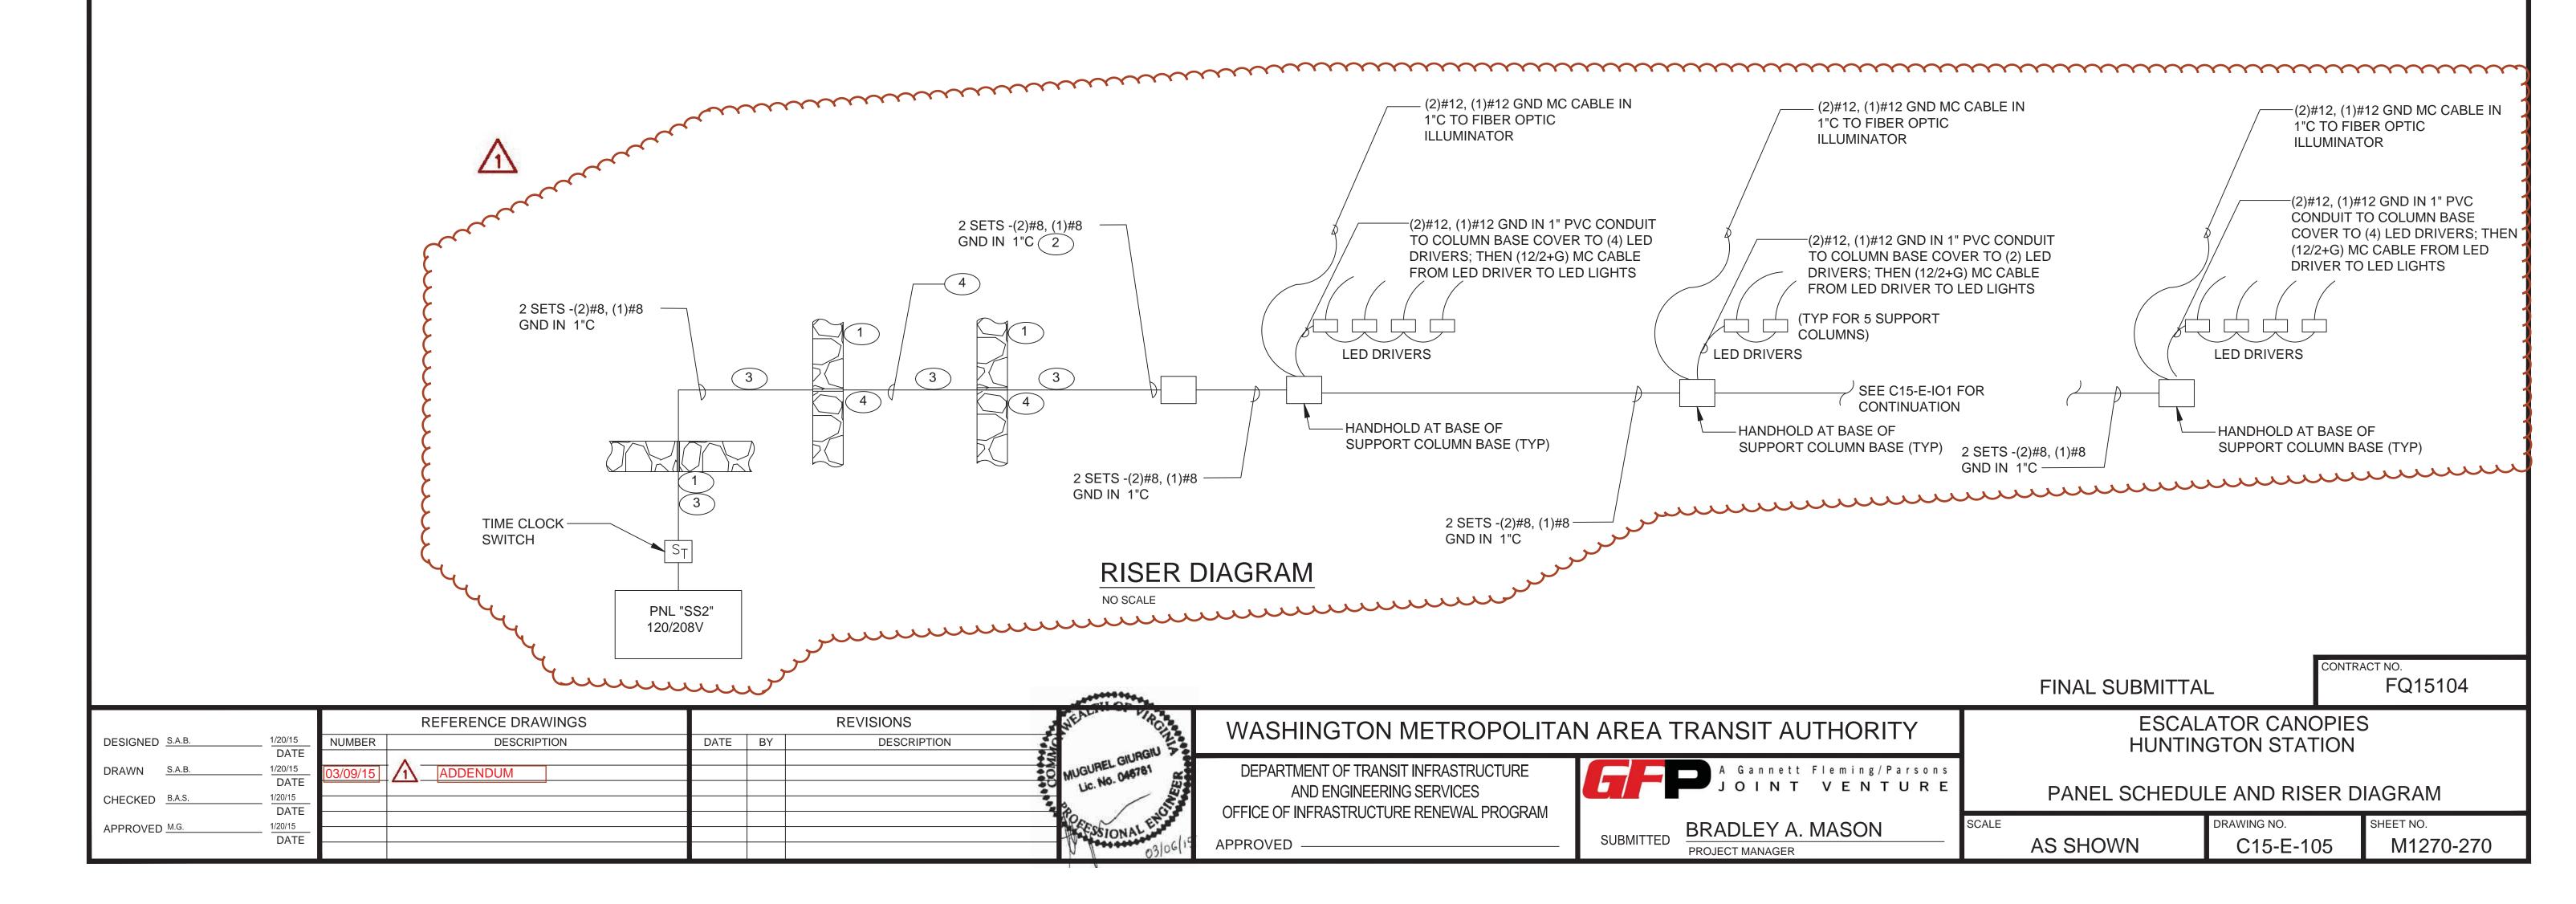

# NOTES:

	CIR.	
	No.	
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) CONCRETE/GRANITE WALL PENETRATION REQUIRED, SLEEVE AND SEAL AT (1)OPENINGS.

( 2 ) ROUTE CONDUIT AND CONDUCTORS EXPOSED DOWN COLUMN TO NEW HANDHOLD.



(3) ROUTE CONDUIT WITH CONDUCTORS PARALLEL TO EXISTING CONDUITS. CONCEAL WHERE POSSIBLE. INSTALL IN A SIMILAR MANNER TO EXISTING. MOUNTING HARDWARE SHALL BE STAINLESS STEEL.

4 WHERE PRACTICAL AND ALLOWED. INSTALLATION OF A CONDULET PREFERRED OVER JUNCTION BOX IN LOCATIONS VISIBLE TO PUBLIC. REFER TO OTHER DRAWINGS FOR INDICATED LOCATIONS.